

Serena McIlwain, Secretary Suzanne E. Dorsey, Deputy Secretary Adam Ortiz, Deputy Secretary

March 10, 2025

Maryland Coastal Bays Program c/o Billy Weiland MD Coastal Bays 8219 Stephen Decatur Hwy Berlin, MD 21811

Via email: bweiland@mdcoastalbays.org

Re: Agency Interest Number: 177619

Tracking Number: 202360233

Tidal Authorization Number: 24-WQC-0040

Dear Maryland Coastal Bays Program:

Your project did not qualify for approval under the Maryland State Programmatic General Permit (MDSPGP); therefore a separate review and issuance of the federal permit will be required by the U.S. Army Corps of Engineers. The federal permit is not attached.

Additionally, your project required a Wetlands License to be approved and issued by the Maryland Board of Public Works (BPW). The Wetlands License will be sent to you by BPW's Wetlands Administrator.

A project that does not qualify for approval under the MDSPGP requires an individual Water Quality Certification (WQC) to be issued by the Maryland Department of the Environment, which is attached. Please take a moment to read and review your WQC to ensure that you understand the limits of the authorized work and all of the general and special conditions.

You should not begin any work until you have obtained all necessary State, local, and federal authorizations. Please contact Robert M Simmons at robertm.simmons@maryland.gov or 410-901-4044 with any questions.

Sincerely,

Jonathan Stewart, Chief Eastern Region

Tidal Wetlands Division



STATE OF MARYLAND DEPARTMENT OF THE ENVIRONMENT WATER AND SCIENCE ADMINISTRATION WATER QUALITY CERTIFICATION



24-WQC-0040

EFFECTIVE DATE: March 10, 2025

CERTIFICATION HOLDER: Maryland Coastal Bays Program

ADDRESS: Attn: B Weiland

8219 Stephen Decatur Hwy

Berlin, MD 21811

PROJECT LOCATION: 11800 Marsh View Ln

Berlin, MD 21811

UNDER AUTHORITY OF SECTION 401 OF THE FEDERAL WATER POLLUTION CONTROL ACT AND ITS AMENDMENTS AND IN ACCORDANCE WITH § 9-313 THROUGH § 9-323, INCLUSIVE, OF THE ENVIRONMENT ARTICLE, ANNOTATED CODE OF MARYLAND, THE MARYLAND DEPARTMENT OF THE ENVIRONMENT, WATER AND SCIENCE ADMINISTRATION HAS DETERMINED THAT THE REGULATED ACTIVITIES DESCRIBED IN THE REQUEST FOR CERTIFICATION FOR THE PROPOSED SINEPUXENT SOUTH SHORELINE STABILIZATION AND AS DESCRIBED IN THE ATTACHED PLAN SHEETS DATED JANUARY 8, 2025 AND ANY SUBSEQUENT MODIFICATIONS APPROVED BY THE DEPARTMENT WILL NOT VIOLATE MARYLAND'S WATER QUALITY STANDARDS, IF CONDUCTED IN ACCORDANCE WITH THE CONDITIONS OF THIS CERTIFICATION.

THIS CERTIFICATION DOES NOT RELIEVE THE APPLICANT OF RESPONSIBILITY FOR OBTAINING ANY OTHER APPROVALS, LICENSES, OR PERMITS IN ACCORDANCE WITH FEDERAL, STATE, OR LOCAL REQUIREMENTS AND DOES NOT AUTHORIZE COMMENCEMENT OF THE PROPOSED PROJECT. A COPY OF THIS REQUIRED CERTIFICATION HAS BEEN SENT TO THE CORPS OF ENGINEERS. THE CERTIFICATION HOLDER SHALL COMPLY WITH THE CONDITIONS LISTED BELOW.

PROJECT DESCRIPTION

- 1. Construct 4 segmented headland breakwaters with cobble toes measuring between 139 and 282 feet long and between 35 and 58 feet wide, all associated with a tombolo style living shoreline with segmented headland breakwaters extending 143 to 275 feet channewlard of the mean high water line;
- 2. Fill and grade with approximately 3,825.7 cubic yards of a sand and 2,475.3 cubic yards of stone for tombolo/habitat construction and plant with 6,749 square feet of low marsh vegetation, 34,047 square feet of high marsh vegetation, and 8,450 square feet of dune vegetation.

The Administration satisfied statutory and regulatory public notice requirements by placing the WQC on Public Notice from October 1, 2024 to October 15, 2024 on the Maryland Department of the Environment's Public Notice webpage. The public notice for the associated Wetland License was advertised on the Maryland Department of the Environment's Public Notice webpage from October 15, 2023 to November 15, 2023 and in the Worcester County Times on October 26, 2023.

GENERAL CONDITIONS

- 1. All water quality-related performance standards and conditions required by the Department in any state issued authorization for activities in tidal wetlands, nontidal wetlands, their 100-year floodplains, nontidal wetlands buffers, or nontidal wetland expanded buffers to ensure that any discharges will not result in a failure to comply with water quality standards in COMAR 26.08.02 or any other water quality requirements of state law or regulation shall be met.
- 2. This Certification does not obviate the need to obtain required authorizations or approvals from other State, federal or local agencies as required by law.
- 3. All additional authorizations or approvals, including self-certifying General Permits issued by the Department, shall be obtained and all conditions shall be completed in compliance with such authorizations.
- 4. The proposed project shall be constructed in accordance with the approved final plan by the Department, or, if Department approval is not required, the plan approved by the U.S. Army Corps of Engineers, and its approved revisions.
- 5. All fill and construction materials not used in the project shall be removed and disposed of in a manner which will prevent their entry into waters of this State.
- 6. This Certification does not authorize any injury to private property, any invasion of rights, or any infringement of federal, state, or local laws or regulations.
- 7. Authorized representatives of the Department shall be provided access to the site of authorized activities during normal business hours to conduct inspections and evaluations of the operations and records necessary to assure compliance with this Certification.
- 8. No stockpiles of any material shall be placed in Waters of the U.S. or state or private tidal wetlands.
- 9. Temporary construction trailers or structures, staging areas and stockpiles shall not be located within tidal wetlands, nontidal wetlands buffers, or the 100-year floodplain unless specifically included on the Approved Plan.
- 10. This Certification is valid for the project identified herein and the associated U.S. Army Corps of Engineers authorization NAB-2023-60233 (MD Coastal Bays Program Sinepuxent South) until such time that it expires or is not administratively extended.

SPECIAL CONDITIONS

1. All Critical Area requirements shall be followed and all necessary authorizations from the Critical Area Commission ("Commission") shall be obtained. This Certificate does not constitute authorization for disturbance in the 100-foot Critical Area Buffer. "Disturbance" in the Buffer means clearing, grading, construction activities, or removal of any size of tree or vegetation. Any anticipated Buffer disturbance requires prior written approval, before commencement of land disturbing activity, from local jurisdiction in the form of a Buffer Management Plan.

- 2. All work performed under this Water Quality Certificate shall be conducted by a marine contractor licensed by the Marine Contractors Licensing Board (MCLB) in accordance with Title 17 of the Environment Article of Annotated Code of Maryland. Licensing by MCLB shall occur prior to the beginning of construction activities. A list of licensed marine contractors may be obtained by contacting the MCLB at 410-537- 3249, by e-mail at MDE.MCLB@maryland.gov or by accessing the Maryland Department of the Environment, Environmental Boards webpage.
- 3. The issuance of this Certificate is not a validation or authorization by the Department for any of the existing structures depicted on the plan sheets on the subject property that is not part of the authorized work description, nor does it relieve the Certificate Holder of the obligation to resolve any existing noncompliant structures and activities within tidal wetlands.
- 4. The Certificate Holder shall construct the marsh establishment area in accordance with the following conditions:
 - a. The Certificate Holder shall use clean substrate fill material, no more than 10% of which shall pass through a standard number 100 sieve.
 - b. The marsh establishment area shall be planted within one year following completion of the filling operation.
 - c. The marsh establishment project shall be maintained as a wetland, with non-nuisance species' aerial coverage of at least 85% for three consecutive years. If 85% coverage is not attained, the reasons for failure shall be determined, corrective measures shall be taken, and the area shall be replanted.
 - d. If the fill is graded hydraulically, the licensee shall use a turbidity curtain around the perimeter of the instream work.
 - e. If the existing bank is to be cleared or graded:
 - The Certificate Holder shall perform all work under and in accordance with an approved Soil Erosion and Sediment Control Plan from the applicable sediment and erosion control agency; and
 - ii. The Certificate Holder shall perform all work under and in accordance with the Critical Area requirements of the local jurisdiction in the form of an approved Buffer Management Plan.
- 5. The Certificate Holder shall accept the terms of the attached marsh maintenance plan by signing and returning the standard plan to the Water and Science Administration, Tidal Wetlands Division prior to commencement of any work authorized under this Certificate. If the Certificate Holder wishes to propose an alternative marsh maintenance plan, the alternative plan must be submitted to and approved by the Tidal Wetlands Division, Water and Science Administration, prior to commencement of any work authorized under this Certificate. Any alternative plan must provide assurances of success that are at least equivalent to those of the standard plan, in terms of the extent of native marsh plant coverage, elimination of invasive species and timeframe for plant establishment.
- 6. The Certificate Holder shall submit photographs on an annual basis for the first five growing seasons to the Tidal Wetlands Division, Water and Science Administration in order to document the success of the project in terms of the extent of native marsh plant coverage. Photographs shall be taken from at least two directions, as necessary to fully depict the living shoreline.
- 7. Due to Submerged Aquatic Vegetation, the Certificate Holder shall perform no in-water work between April 15 and October 15 of any year.

STATEMENTS OF NECESSITY & CITATIONS

1. Statement of Necessity for General Conditions 1, 2, 3, 4, and Special Conditions 1, 3: These conditions are necessary to ensure that water quality standards are met, and designated uses are maintained.

Citations: Federal and state laws which authorize this condition include but are not limited to: 33 U.S.C. § 1341(a), (b), & (d); 33 U.S.C. § 1251(b); 33 U.S.C. § 1370; Md. Ann. Code, Env. Article, Title 1, Subtitles 3 and 4; Md. Ann. Code, Env. Article, Title 5, Subtitles 5 and 9; Md. Ann. Code, Env. Article, Title 9, Subtitle 3; Md. Ann. Code, Env. Article, Title 16; COMAR 26.08; COMAR 26.08.02.10G(3); COMAR 26.23.02.06; COMAR 26.17.01; COMAR 26.23; COMAR 26.24

2. Statement of Necessity for General Conditions 5, 8, 9, and Special Conditions 4, 5, 6: Fill or construction material within or adjacent to regulated resources may cause discharges resulting in turbidity in excess of water quality standards and interfere with designated uses of growth and propagation of fish, other aquatic life, wildlife; and other designated uses; and fail to meet general water quality criteria that waters not be polluted by substances in amounts sufficient to be unsightly or create a nuisance.

Citation: 26.08.02.03B(1)-B(2); COMAR 26.23; COMAR 26.24; COMAR 26.17.04

3. Statement of Necessity for General Condition 6: This condition is necessary to clarify the scope of this certification to ensure compliance with water quality regulations, without limiting restrictions through other requirements.

Citation: Federal and state laws which authorize this condition include but are not limited to: 33 U.S.C. § 1341(a), (b), & (d); 33 U.S.C. § 1251(b); 33 U.S.C. § 1370; Md. Ann. Code, Env. Article, Title 1, Subtitles 3 and 4; Md. Ann. Code, Env. Article, Title 5, Subtitles 5 and 9; Md. Ann. Code, Env. Article, Title 9, Subtitle 3; Md. Ann. Code, Env. Article, Title 16; COMAR 26.08, COMAR 26.08.02.10E; COMAR 26.23.02.06; COMAR 26.17.04; COMAR 26.23; COMAR 26.24

4. Statement of Necessity for General Condition 7: Conditions of certification involve precise actions to comply with water quality standards. Site inspection may be necessary to ensure that limits, methods, and other requirements are met to ensure that water quality standards are met and designated uses are maintained. These conditions are necessary to ensure that the activity was conducted, and project completed according to terms of the authorization/certification, while allowing for review of in-field modifications which may have resulted in discharges to ensure that water quality standards were met. Designated uses include support of estuarine and marine aquatic life and shellfish harvesting and for growth and propagation of fish, other aquatic life, and wildlife

Citation: Federal and state laws that authorize this condition include but are not limited to: 33 U.S.C. § 1341(a), (b), & (d); 33 U.S.C. § 1251(b); 33 U.S.C. § 1370; Md. Ann. Code, Env. Article, Title 1, Subtitles 3 and 4; Md. Ann. Code, Env. Article, Title 5, Subtitles 5 and 9; Md. Ann. Code, Env. Article, Title 9, Subtitle 3; Md. Ann. Code, Env. Article, Title 16; COMAR 26.08; COMAR 26.08.02.03B(1)(b); COMAR 26.08.02.03B(2); COMAR 26.23.02.06; COMAR 26.23; COMAR 26.24; COMAR 26.17.04

5. Statement of Necessity for General Condition 10: This condition is necessary to qualify the period of applicability of the terms and conditions of this Certification to be protective of Maryland water quality standards.

Citations: Federal and state laws which authorize this condition include but are not limited to: 33 U.S.C. § 1341(a), (b), & (d); 33 U.S.C. § 1251(b); 33 U.S.C. § 1370; 40 C.F.R. 121, 15 C.F.R. 930, Md. Ann. Code, Env. Article, Title 1, Subtitles 3 and 4; Md. Ann. Code, Env. Article, Title 5, Subtitles 5 and 9; Md. Ann. Code, Env. Article, Title 9, Subtitle 3; Md. Ann. Code, Env. Article, Title 16; COMAR 26.08; COMAR 26.17.04; COMAR 26.23; COMAR 26.24

6. Statement of Necessity for Special Condition 2: Expertise for conducting certain activities is required to ensure that there is no violation of water quality standards nor interference with designated uses. This condition is necessary to ensure that discharges will be conducted in a manner which does not violate water quality criteria nor interfere with designated uses.

Citation: COMAR 26.08.02.02B(2)- B(4); COMAR 26.08 02.03B(2)(d) – (e); COMAR 26.08.02.03B(1)(b); 26.08.02.03B(2); COMAR 23.02.04.04

7. Statement of Necessity for Special Conditions 4, 5, 6: Tidal wetlands provide essential habitat, water quality, food, and movement corridors for wildlife, and support of estuarine and marine aquatic life and shellfish harvesting. Successful establishment is necessary to prevent discharges which interfere with designated uses, including growth and propagation of fish, other aquatic life, and wildlife through loss of stream channel habitat and wetlands. Required establishment, re-establishment, or enhancement and loss limits will maintain the designated use.

Citations: COMAR 26.08.02.02B(3); COMAR 26.08.02.03B(3) and B(4); COMAR 26.24.

8. Statement of Necessity for Special Condition 7: A time of year restriction is necessary to maintain the designated use for support of estuarine and marine aquatic life and shellfish harvesting.

Mar 14, 2025

Date

Citation: Federal and state laws which authorize this condition include but are not limited to: COMAR: 26.08.02.02B(1)(d); 26.08.02.02B(3); COMAR 26.08.02.02-16.

CERTIFICATION APPROVED

Matthew C. Rowe
Matthew C. Rowe (Mar 14, 2025 07:42 EDT)

D. Lee Currey, Director Water and Science Administration


Tracking Number: 202360233 Agency Interest Number: 177619

Effective Date: March 10, 2025

Enclosure: Plan Sheets dated January 8, 2025

cc: WSA Inspection & Compliance Program

Army Corps of Engineers

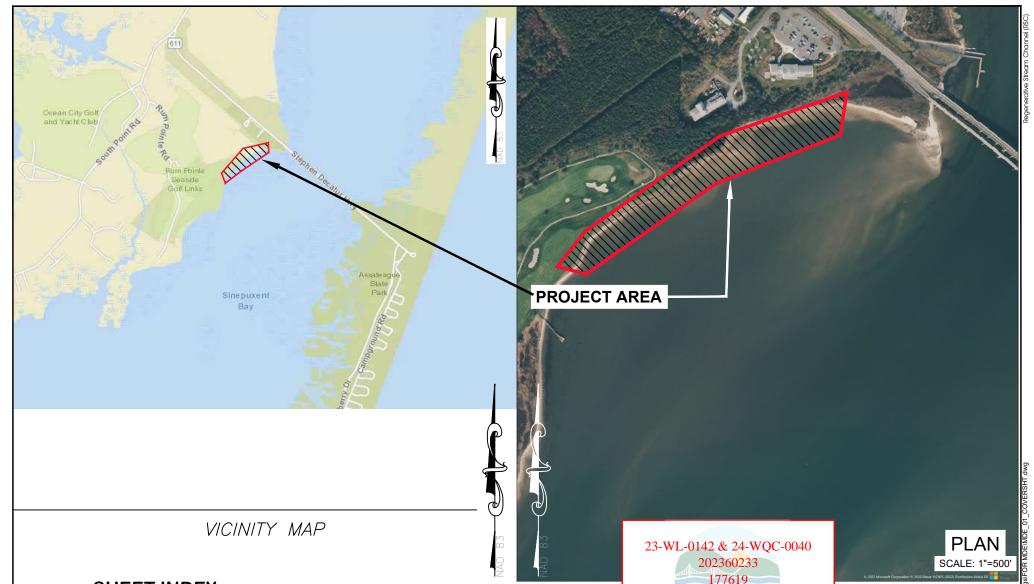

SHEET INDEX

DESCRIPTION SHEET VICINITY MAP AND AERIAL PHOTO......1 PROJECT VICINITY CONDITIONS _____2 EXISTING CONDITIONS 3 - 4 PROPOSED CONDITIONS 5 - 7 PROJECT CROSS SECTIONS 8 - 10 BUFFER MANAGEMENT PLAN11 - 13 PROJECT DATA TABLES14 BUFFER MANAGEMENT SCHEDULE15

UNDERWOOD & ASSOCIATES LANDSCAPE ARCHITECTURE ECOLOGICAL RESTORATION A DESIGN/BUILD Co. 1753 EBLING TRAIL • ANNAPOLIS, MD 21401 tel. 410-849-3211 fax. 410-849-2136 Proposal No.


Scale AS SHOWN Drawn By J.H./J.K./E.C SINEPUXENT SOUTH Approved By K.B. Sheet No. 1 Of 15 Project No. 21-032


VICINITY MAP AND AERIAL PHOTO


JANUARY 8, 2025


LIVING SHORELINE
11800 MARSH VIEW LANE, BERLIN, MD 21811 MAP 0042, GRID 0020, PARCEL 0008 1ST ELECTION DISTRICT, WORCESTER COUNTY


202360233 / 23-WL-0142

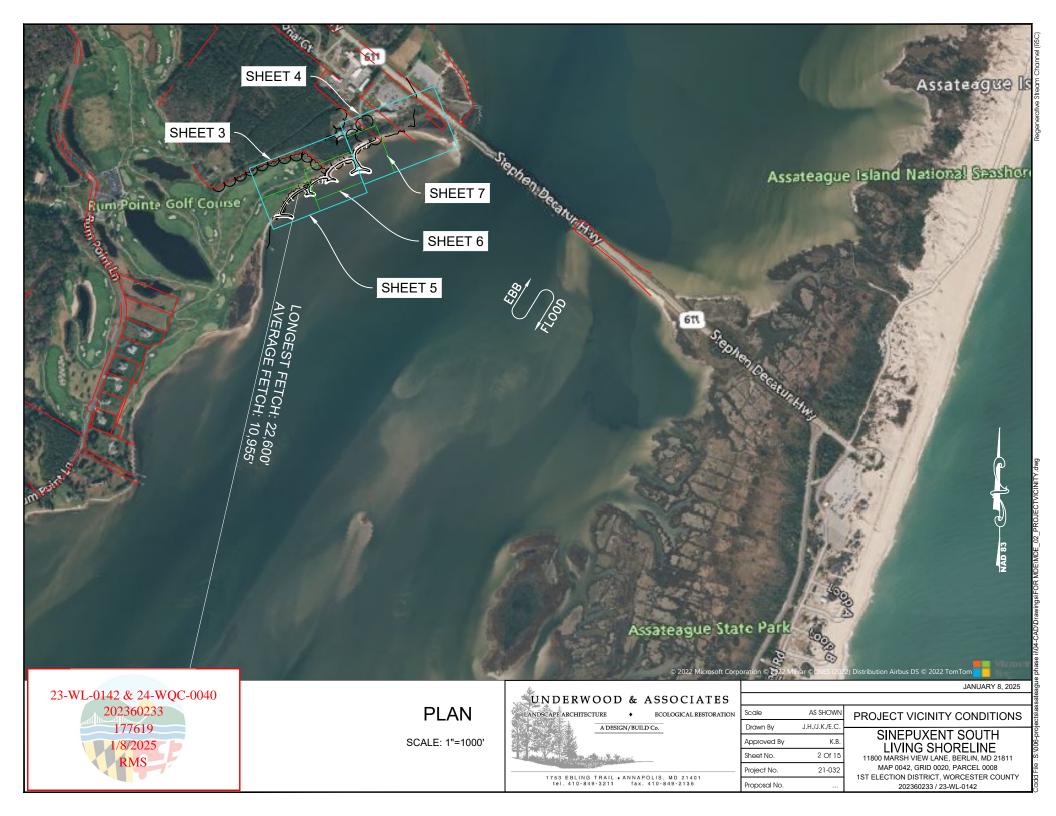


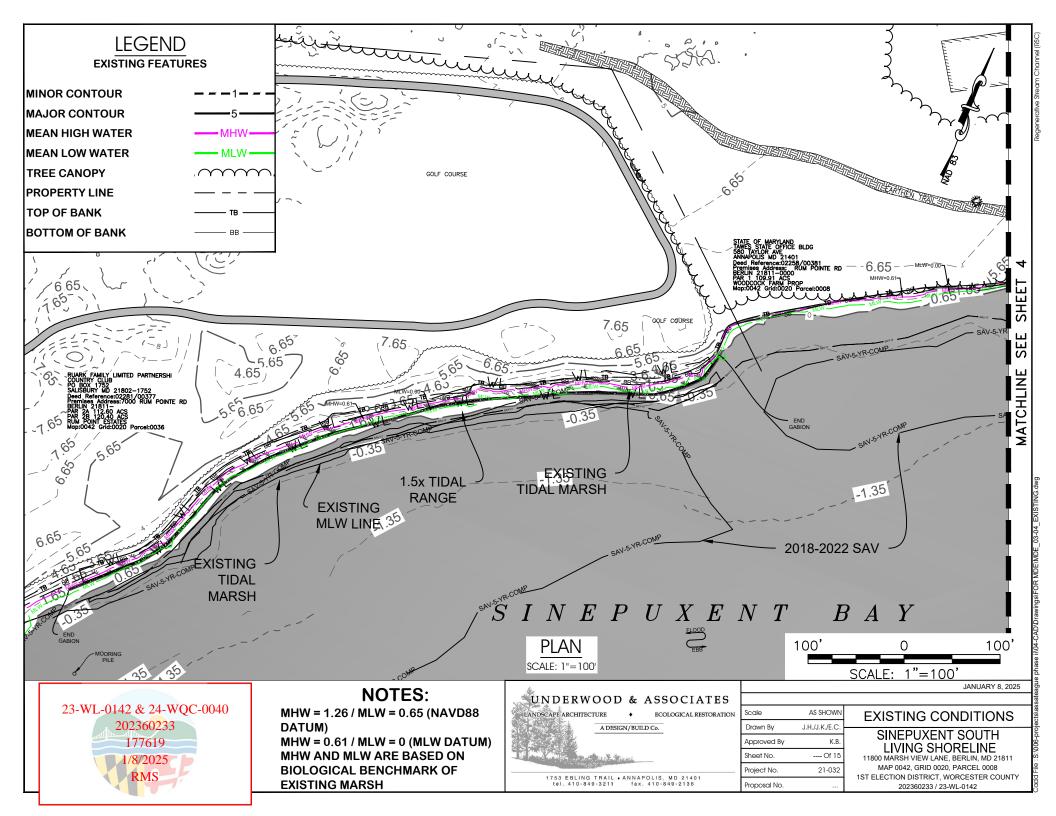


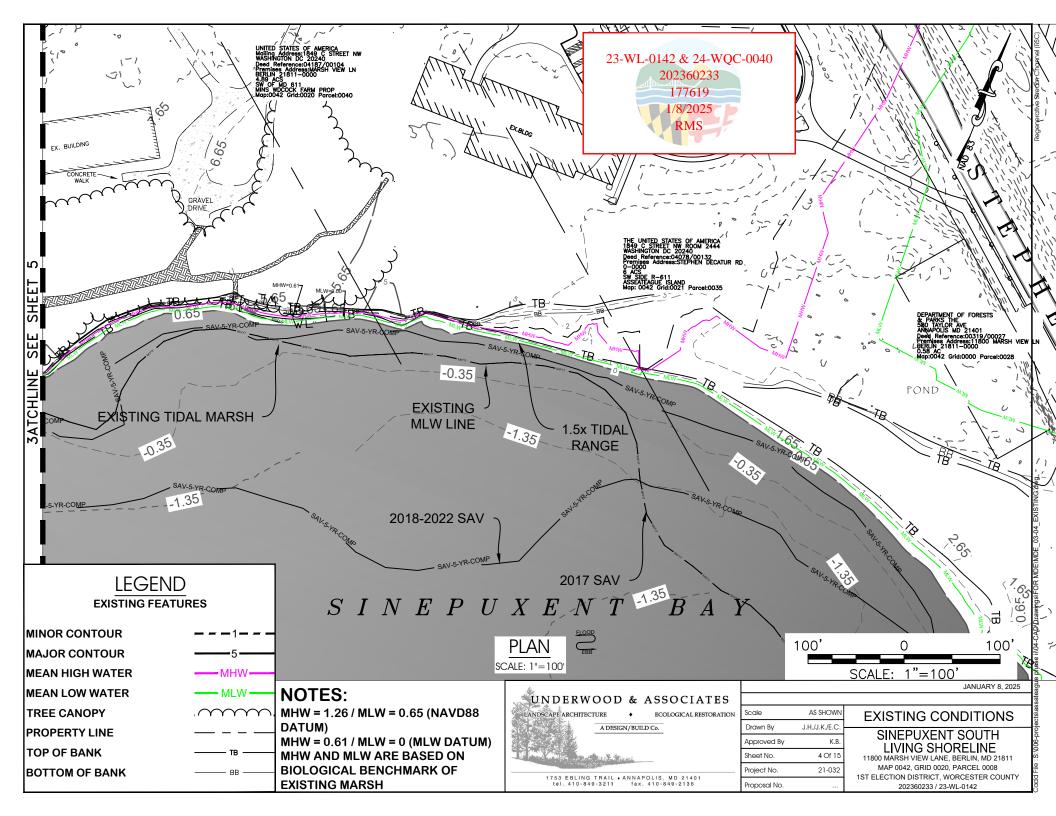


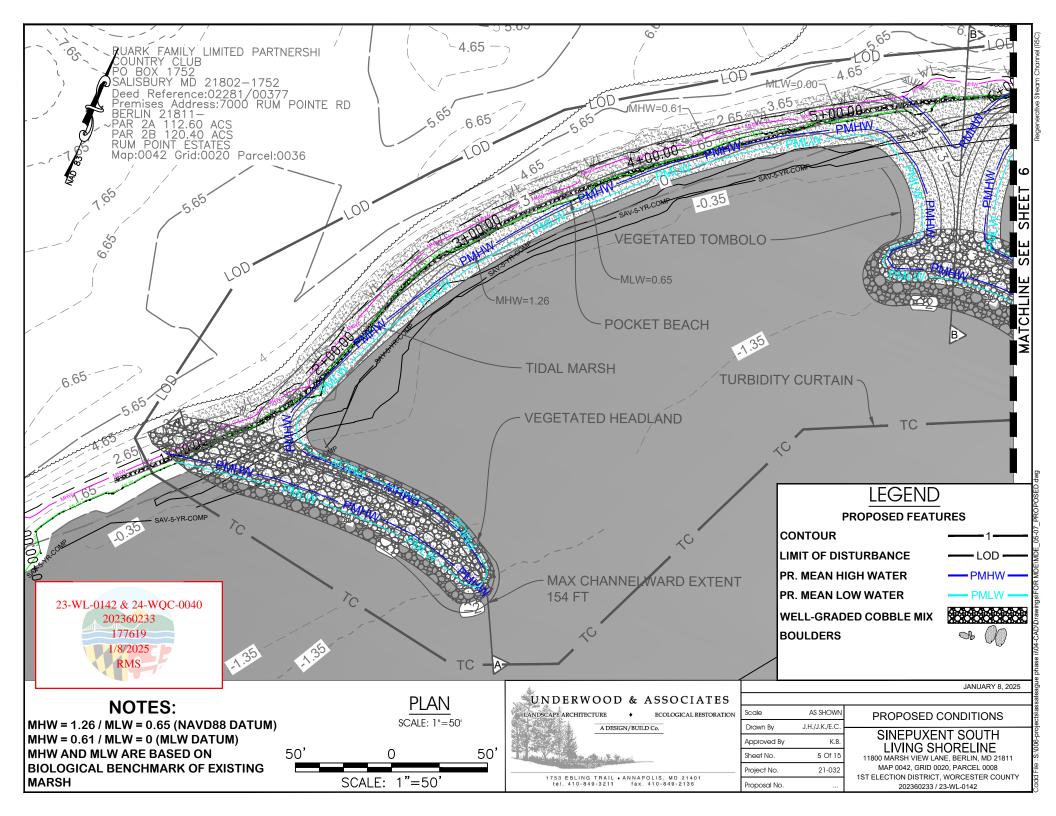

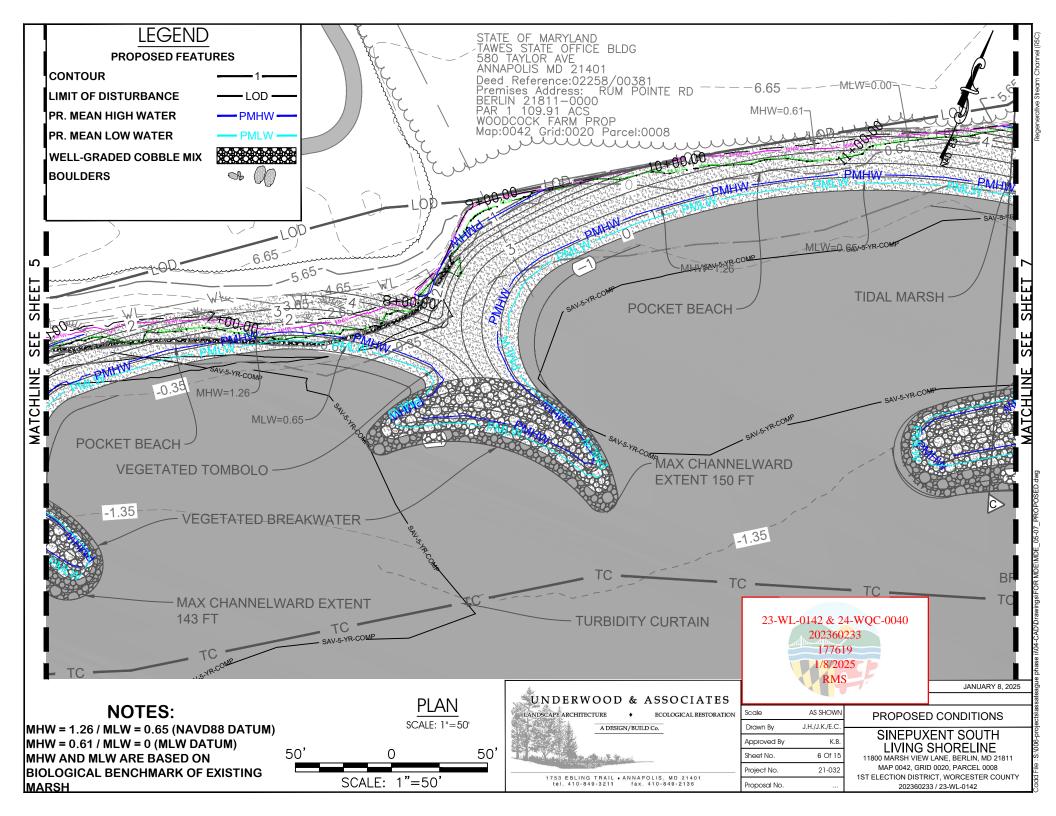

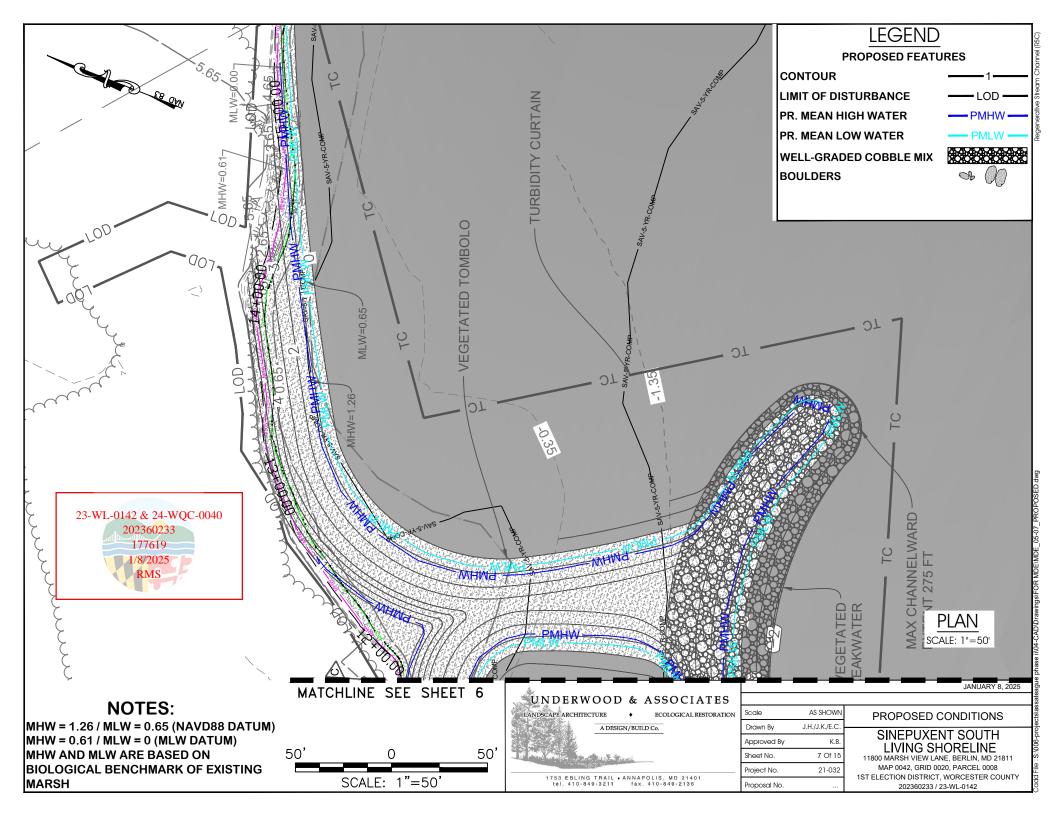

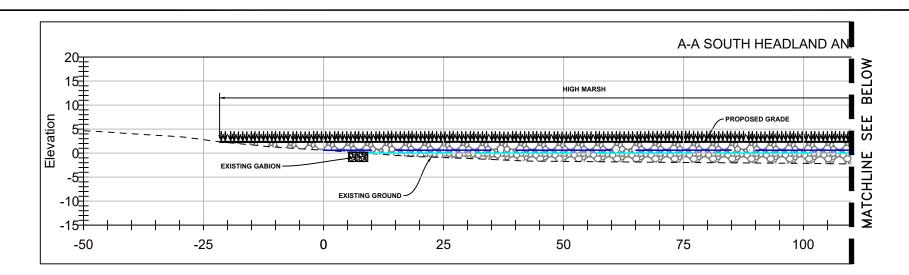

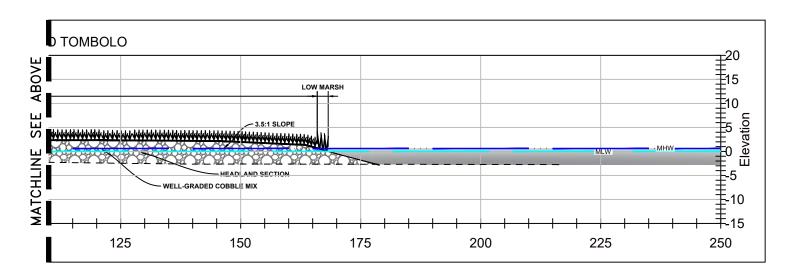

LEGEND **EXISTING GRADE** PROPOSED GRADE **MEAN HIGH WATER (MHW) MEAN LOW WATER (MLW)** SAND/WOOD CHIP MIX **WELL-GRADED COBBLE MIX BOULDER**

CROSS SECTIONS

SCALE: HORI. 1"=20', VERT. 1"=20'

23-WL-0142 & 24-WQC-0040 202360233 177619

NOTES:

MHW = 1.26 / MLW = 0.65 (NAVD88 DATUM) MHW = 0.61 / MLW = 0 (MLW DATUM)MHW AND MLW ARE BASED ON BIOLOGICAL BENCHMARK OF EXISTING MARSH


*		
UNDERWOOD & ASSOCIATES		
LANDSCAPE ARCHITECTURE	Scale	AS SHOWN
A DESIGN/BUILD Co.	Drawn By	J.H./J.K./E.C.
	Approved By	K.B.
	Sheet No.	8 Of 15
	Project No.	21-032
1753 EBLING TRAIL • ANNAPOLIS, MD 21401 tel. 410-849-3211 fax. 410-849-2136	Proposal No.	

PROJECT CROSS SECTION

JANUARY 8, 2025

SINEPUXENT SOUTH LIVING SHORELINE

11800 MARSH VIEW LANE, BERLIN, MD 21811 MAP 0042, GRID 0020, PARCEL 0008 1ST ELECTION DISTRICT, WORCESTER COUNTY 202360233 / 23-WL-0142

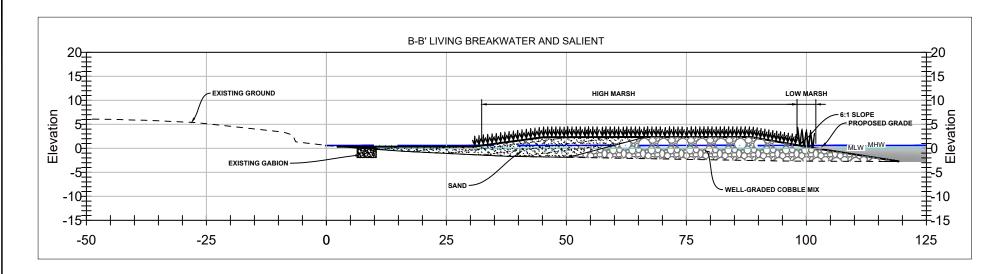

CROSS SECTIONS

SCALE: HORI. 1"=20'. VERT. 1"=20'

EXISTING GRADE PROPOSED GRADE MEAN HIGH WATER (MHW) MEAN LOW WATER (MLW) SAND/WOOD CHIP MIX WELL-GRADED COBBLE MIX BOULDER

NOTES:

AS SHOWN

K.B.

9 Of 15

21-032

J.H./J.K./E.C

MHW = 1.26 / MLW = 0.65 (NAVD88 DATUM)
MHW = 0.61 / MLW = 0 (MLW DATUM)
MHW AND MLW ARE BASED ON BIOLOGICAL
BENCHMARK OF EXISTING MARSH





PROJECT CROSS SECTION

SINEPUXENT SOUTH LIVING SHORELINE

JANUARY 8, 2025

11800 MARSH VIEW LANE, BERLIN, MD 21811
MAP 0042, GRID 0020, PARCEL 0008
1ST ELECTION DISTRICT, WORCESTER COUNTY
202360233 / 23-WL-0142

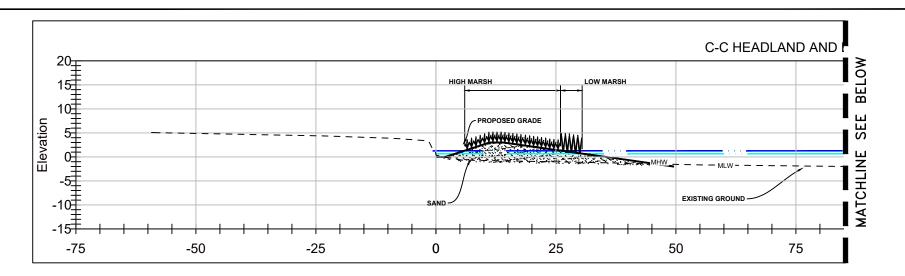

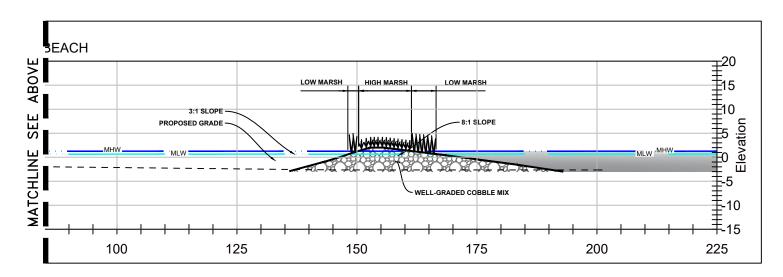

EXISTING GRADE
PROPOSED GRADE
MEAN HIGH WATER (MHW)
MEAN LOW WATER (MLW)
SAND/WOOD CHIP MIX
WELL-GRADED COBBLE MIX
BOULDER

CROSS SECTIONS

SCALE: HORI. 1"=20', VERT. 1"=20'

NOTES:

MHW = 1.26 / MLW = 0.65 (NAVD88 DATUM)
MHW = 0.61 / MLW = 0 (MLW DATUM)
MHW AND MLW ARE BASED ON BIOLOGICAL
BENCHMARK OF EXISTING MARSH



	UNDERWOOD & ASSOCIATES	
	LANDSCAPE ARCHITECTURE • ECOLOGICAL RESTORATION	S
	A DESIGN/BUILD Co.	[
		/
	and the same of th	S
		F
_	1753 EBLING TRAIL • ANNAPOLIS, MD 21401 tel. 410-849-3211 fax. 410-849-2136	F


1	Scale	AS SHOWN	
	Drawn By	J.H./J.K./E.C.	
	Approved By	K.B.	
	Sheet No.	10 Of 15	
-	Project No.	21-032	
	Proposal No.		'


PROJECT CROSS SECTION


JANUARY 8, 2025

SINEPUXENT SOUTH LIVING SHORELINE

11800 MARSH VIEW LANE, BERLIN, MD 21811 MAP 0042, GRID 0020, PARCEL 0008 IST ELECTION DISTRICT, WORCESTER COUNTY 202360233 / 23-WL-0142

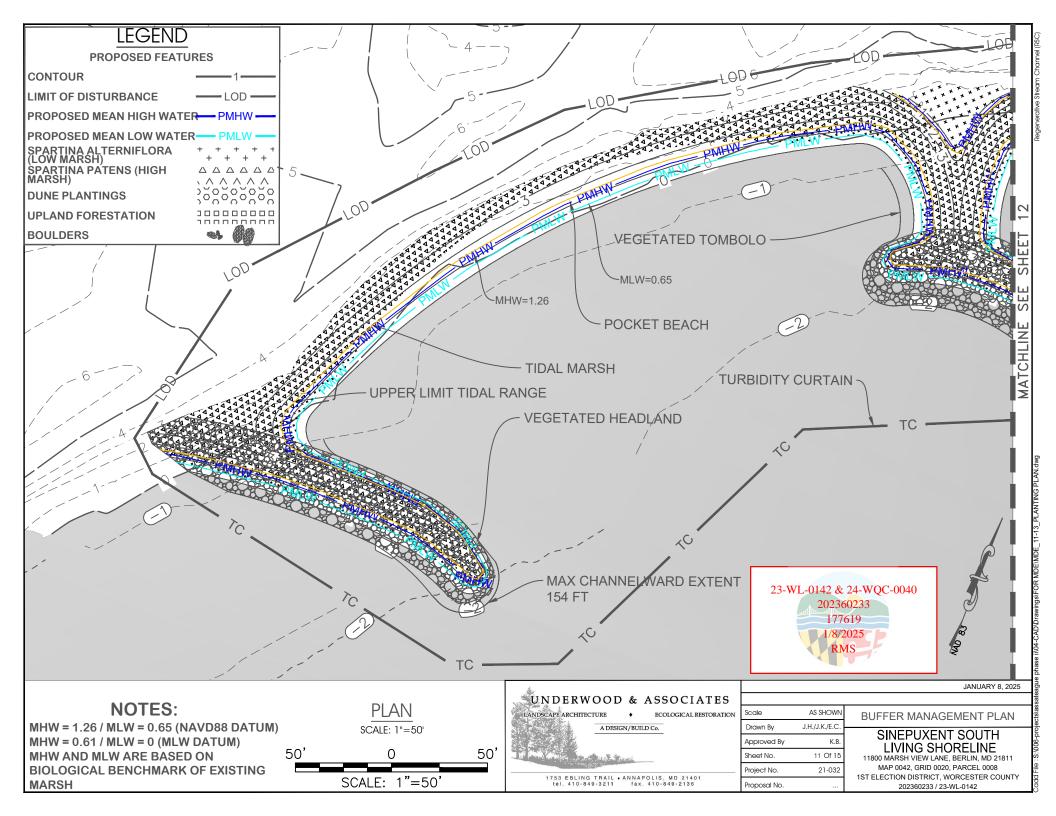

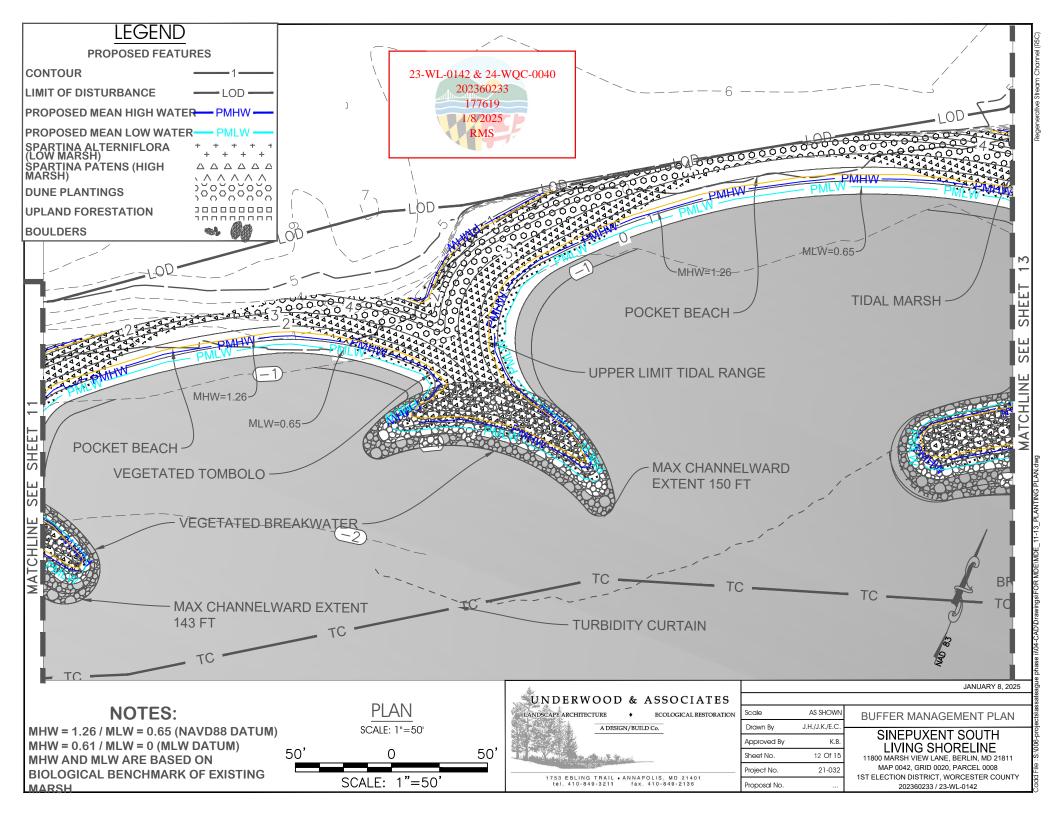

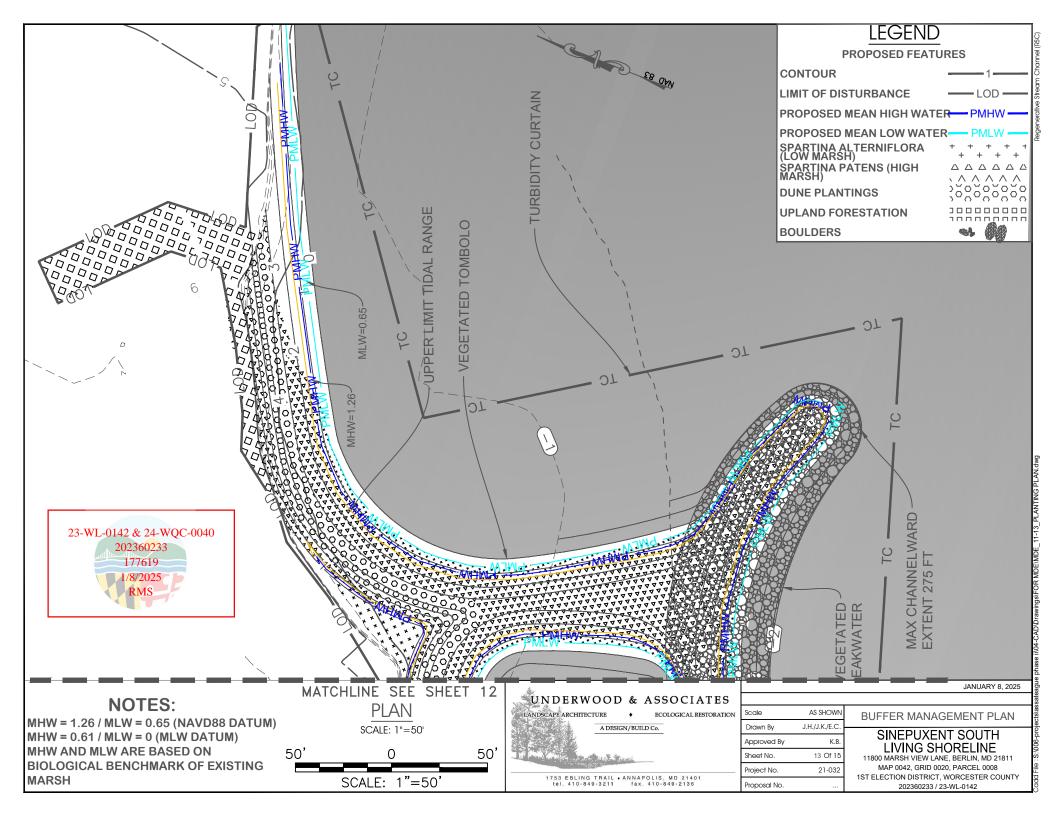

PROJECT DATA TABLES

233	Tidal Wetlands Impacts and Creation Summary								
25 b	Resource Type	High Marsh (S. patens)	Low Marsh (S. alterniflora)	SAV	Open Water				
	Delineation Notes	up to +2.15 MLW (upper limit of existing marsh) between MHW & MLW		2018 - 2022 VIMS composite	other areas below MHW				
	Project Impact (acres)	0.086	0.085 0.47		1.620				
Anticipated	Post-Project [created or recolonized] (acres)	0.510 0.101		0.551	0.000				
	In-Kind Ratio	1:1	1:1	1 1:1					
In-Kind (acres)		0.086	0.085	0.474	0.000				
Out-of-Kind Replacement Ratio		2:1	2:1	2:1	1:1				
Out-of-Kind Replacement Type		-	-	-	High Marsh				
Out-of-Kind (total created acres)		0.000	0.000	0.000	0.424				
Out-of-Kind (credit acres)		0.000	0.000	0.000	0.424				
Combination In-Kind and Out-of-Kind Provided (credit acres)		0.086	0.085	0.474	0.424				
Adequate Replacement Provided?		Yes	Yes Yes		No				
Ex	cess Replacement Provided (acres)	0.424	0.015	0.077	0.000				

0.000

0.000

Sinepuxent South Living Shoreline - Project Information								
Feature	Existing	Proposed	Difference					
High marsh- S. patens (SF)	3745	22233	18488					
Low marsh - S. alterniflora (SF)	3718	8646	4928					
Total Tidal Wetlands (SF)	7463	30879	23416					
Bulkhead (LF)	0.0	0.0	0.0					
Gabion Baskets (LF)	751.3	0.0	-751.3					
Shoreline at MHW (LF)	1406.0	2665.5	1259.5					
Sand Fill Area (SF)	0.0	50087.3	50087.3					
Sand Fill Volume (CY)	0.0	4218.0	4218.0					
Vegetated Rock Fill Area (SF)	0.0	14586.2	14586.2					
Unvegetated Rock Fill Area (SF)	0.0	12392.5	12392.5					
Rock Fill Volume (CY)	0.0	1705.0	1705.0					
Total Channelward Fill Area (SF)	0.0	77066.0	77066.0					
Total Channelward Fill Volume (CY)	0.0	5923.0	5923.0					

DATUM TRANSFORMATIONS

1.195

ELEVATIONS ON THESE PLANS ARE REFERENCED TO MLW = 0

TO BE IN AGREEMENT WITH THE CONSTRUCTION PLANS, SUBTRACT 0.65 FROM ALL ELEVATIONS

0.000

DATA IN FT FROM BIOLOGICAL BENCHMARK
NAVD88 MLW

1.26 0.61 MHW - MEAN HIGH WATER

0.65 0.00 MLW - MEAN LOW WATER

-0.65 NAVD88 - NORTH AMERICAN VERTICAL DATUM OF 1988

Note: All existing tidal marsh impacts and proposed creations are restricted to the field delineated upper limit of existing tidal wetlands using field verified tidal data (biological benchmark of existing marsh).

Replacement Deficit (acres)



 Scale
 AS SHOWN

 Drawn By
 J.H./J.K./E.C.

 Approved By
 K.B.

 Sheef No.
 14 Of 15

 Project No.
 21-032

 Proposal No.
 ...

PROJECT DATA TABLES

JANUARY 8, 2025


SINEPUXENT SOUTH LIVING SHORELINE 11800 MARSH VIEW LANE, BERLIN, MD 21811

MAP 0042, GRID 0020, PARCEL 0008 1ST ELECTION DISTRICT, WORCESTER COUNTY 202360233 / 23-WL-0142

phase ii\04-CAD\Drawings\FOR MDE\MDE_14-15_TABLES.dw

BUFFER MANAGEMENT PLAN PLANTING SCHEDULE													
Planting Zone	Symbol	Total Area (Ft^2)	Common Name	Scientific Name	Туре	Wetland Indicator Status	Size	Distribution	Avg Spacing (ft)	Quantity	Credit Area (SF per plant)	Total Credit Area (SF)	Description
Lowmarsh Cordgrass	Pluses	8,646	Lowmarsh Cordgrass	Spartina alterniflora	SAV	OBL	Gal	Random	2.5	1,384	0	0	Between PMLW and PMHW.
Highmarsh Cordgrass	Triangles	34,047	Highmarsh Cordgrass	Spartina patens	SAV	FACW+	Gal	Random	2.5	5,448	0	0	Between PMHW to proposed elevation 3 ft NAVD88 (3.7 ft MLW)
			Evening primrose	Oenothera humifusa	Herbaceous	FACU	Qt	Random	5	49	2	98	
			Beach plum	Prunus maritima	Shrub	UPL	2-3'	Random	8	19	50	950	
			Bitter panicgrass	Panicum amarum	Herbaceous	FACU-	Qt	Random	5	49	2	98	All newly created areas
Dune	Hexagons	8,450	American beachgrass	Ammophila breviligulata	Herbaceous	FACU	Qt	Random	5	49	2	98	a bove el evation 3 ft NAVD88 (3.7 ft MLW)
			Switchgrass	Panicum virgatum	Herbaceous	FAC	1-2'	Random	8	19	50	950	
			Seaside goldenrod	Solidago sempervirens	Herbaceous	FACW	1-2'	Random	8	19	50	950	
			Prickly pear	Opuntia humifosa	Herbaceous	N/A	Qt	Random	5	49	2	98	
			Southern bayberry	Myrica cerifera	Shrub	FAC	2-3'	Random	8	9	2	18	
			Eastern red cedar	Juniperus virginiana	Tree	FACU	2-3'	Random	15	3	50	150	
			Persimmon	Diospyros virginiana	Tree	FAC	2-3'	Random	15	3	50	150	Primarily the upland
Upland Forestation	Squares	3,672	Black gum	Nyssa sylvatica	Tree	FAC	2-3'	Random	15	3	50	150	canopy area impacted by
Forestation			American Holly	Ilex opaca	Tree	FAC	2-3'	Random	15	3	100	300	construction access
			Black Chokeberry	Prunus virginiana	Tree	FACU	2-3'	Random	15	3	100	300	
			Southern Red Oak	Quercus falcata	Tree	FACU	2-3'	Random	15	3	100	300	
Calabara Aurara	distantian Cal	lau latione	Total Area of	Disturbed Canopy (SF)	Mitigation Ratio		Total Mitigation Credit Required (SF)		Total Credit Area (SF)		Percent Mitigation (%)		
Critical Area N	viitigation Ca	iculations		3,672		1:1	_		3,672		4,6	10	126%



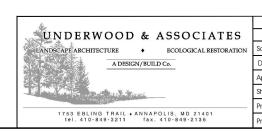

Scale AS SHOWN Drawn By J.H./J.K./E.C.
Approved By K.B.
Sheet No. 15 Of 15
Project No. 21-032
Proposal No. ...

AS SHOWN BUFFER MANAGEMENT SCHEDULE SINEPUXENT SOUTH

JANUARY 8, 2025

LIVING SHORELINE
11800 MARSH VIEW LANE, BERLIN, MD 21811
MAP 0042, GRID 0020, PARCEL 0008
1ST ELECTION DISTRICT, WORCESTER COUNTY
202360233 / 23-WL-0142

24-WQC-0040 (final)

Final Audit Report 2025-03-14

Created: 2025-03-11

By: Jonathan Stewart (jon.stewart@maryland.gov)

Status: Signed

Transaction ID: CBJCHBCAABAAxRYR75Rt_5mMz85W_g-j6r8MgWkgTNS5

"24-WQC-0040 (final)" History

Document created by Jonathan Stewart (jon.stewart@maryland.gov) 2025-03-11 - 5:33:19 PM GMT

Document emailed to mde.wsaepermits@maryland.gov for signature 2025-03-11 - 5:35:19 PM GMT

Email viewed by mde.wsaepermits@maryland.gov 2025-03-14 - 11:42:10 AM GMT

Signer mde.wsaepermits@maryland.gov entered name at signing as Matthew C. Rowe 2025-03-14 - 11:42:54 AM GMT

Document e-signed by Matthew C. Rowe (mde.wsaepermits@maryland.gov)
Signature Date: 2025-03-14 - 11:42:56 AM GMT - Time Source: server

Agreement completed. 2025-03-14 - 11:42:56 AM GMT