

State of Maryland **Board of Public Works**

Wetlands Administration 80 Calvert Street, Room 117, Annapolis, Maryland 21401 410-260-7791 Wes Moore

Governor

Dereck E. Davis *Treasurer*

Brooke Lierman *Comptroller*

John T. Gontrum, Esq. *Executive Secretary*

WETLAND LICENSE NO. 23-0762 TRADEPOINT TIL TERMINALS (TTT) LLC

The Maryland Board of Public Works authorizes you to:

- I. **Excavation**: Excavate approximately 133,361 cubic yards of upland material to create 6.37 acres (277,329 square feet) of tidal open water with depths ranging from mean high water to -52.22 MLW. The excavated upland material will be reused or disposed of on site or at appropriate upland facilities.
- II. **Dredging**: Mechanically dredge a 135.68-acre (5,907,855 square foot) channel to a depth of 52.22 feet at mean low water; and to deposit approximately 4.2 million cubic yards (MCY) of dredged material at the following approved placement sites: a maximum of 350,000 CY of slag will be reused on site, a maximum of 1.7 MCY at the High Head Industrial Basin dredge material containment facility (DMCF), a maximum of 1.57 MCY at the Norfolk Ocean Disposal Site (NODS), and a maximum of 1.25 MCY at either Maryland Port Authority (MPA) Cox Creek DMCF or Masonville DMCF.
- III. Provide for periodic maintenance dredging for six years.

IV. Wharf Construction:

- 1. Fill 0.29 acres (12,468 square feet) of open water;
- 2. Construct 3,310 linear feet of stone or concrete revetment within a maximum of 171 feet channelward of the proposed mean high water line:
- 3. Construct an 8.82-acre (384,000 square foot) marginal wharf, supported with one hundred and fiftythree (153), 30-inch diameter piles; and one thousand and sixty-one (1,061), 36-inch diameter piles
- 4. along 3,000 linear feet of shoreline, extending a maximum of 128.5 feet channelward of the proposed mean high water line. The wharf will include nine Ship to Shore (STS) cranes with active
- 5. cranes extending a maximum of 330 feet above the wharf platform and stored cranes extending a maximum height of 484 feet above the wharf platform. The wharf will also include rail and other
- 6. accessory features required for the function of a marine container terminal.
- 7. Construct three 60-inch diameter stormwater discharges with associated stone outfall structures:
 - a. Outfall 1: 626 square feet within 20 feet channelward of the mean high water line;
 - b. Outfall 2: 280 square feet within 23 feet channelward of the mean high water line;

c. Outfall 3: 800 square feet within 98 feet channelward of the mean high water line;

The construction of these outfalls includes construction of a temporary cofferdams that result in a total temporary impact of 2,479 square feet.

V. **Temporary High Head DMCF Outfall**: Construct a new 650-foot long temporary outfall for DMCF dewatering activity consisting of a 24-inch diameter feeder line pipe extending 550 feet channelward of the mean high water line with an associated 18-inch diameter multiport diffuser extending a maximum of 650 feet channelward of the mean high water line.

Patapsco River, Coke Point Peninsula at Tradepoint Atlantic, 6995 Bethlehem Boulevard, Suite 100, Baltimore City, Maryland

Issuance of this Tidal Wetlands License constitutes the State's determination that the authorized activities are consistent with the Maryland Coastal Zone Management Program (CZMP), as required by Section 307 of the Federal Coastal Zone Management Act of 1972, as amended [16 U.S.C. §1456]. Accordingly, the State concurs with the Licensee's certification in the Joint Permit Application that the project complies with and will be conducted in a manner consistent with the Maryland CZMP.

THIS LICENSE AUTHORIZES YOU TO PERFORM THE WORK ONLY IF YOU COMPLY WITH THE FOLLOWING SPECIAL CONDITION(S):

- A. Due to the presence of anadromous fish, no dredging shall occur between April 1 and October 1 of any year.
- B. Dredge Material Disposal and Best Management Practice (BMP) Plan. No dredging activity can commence prior to the Tidal Wetlands Division's approval of the Dredge Material Disposal and BMP Plan. The Dredge Material Disposal and BMP Plan shall be submitted for review and approval at least 30 days prior to the commencement of any dredging authorized in this License. The Licensee shall implement and comply with the Dredge Material Disposal and BMP Plan, which will detail support for the implementation of appropriate practices to protect water quality, marine life, and estuarine habitat; and will include the criteria for when an environmental bucket for dredging and water-tight trucks and scows for transport will be used. The Dredge Material Disposal and BMP Plan shall also detail the sequence of dredging activity that includes DMCF construction, dredging schedule, placement approval letters from accepting facilities, and dredge transportation activities. The Dredge Material Disposal and BMP Plan can only be modified upon approval by the Tidal Wetlands Division.\
- C. The Licensee shall conduct subsequent maintenance dredging within the scope of this license in terms of authorized dredge area and authorized depths. The licensee shall:
 - 1. Dredge no more than 500 cubic yards of material at each maintenance dredging.
 - 2. Comply with all applicable conditions of this license.
 - 3. Submit a detailed dredged material disposal plan to be approved by the Water and Science Administration, Tidal Wetlands Division prior to the start of dredging.
 - 4. Notify and receive approval from the Water and Science Administration, Compliance Program, a minimum of 10 days prior to the start of each maintenance dredging operation.
- D. The Licensee shall demonstrate delineation of the dredge area and receive approval from the Water and Science Administration's Compliance Division prior to the start of dredging.

E. The Licensee shall conduct a post dredge bathymetric survey and forward to the Water and Science Administration, Tidal Wetlands Division within 45 days after the termination of any phase of dredging.

- F. The Licensee shall dispose of dredged material only at the dredge disposal site(s) approved by this Wetland License. The Licensee shall submit an application for modification of the License to MDE for approval of any dredge disposal site not authorized within this License.
- G. Pile Driving Best Management Practice (BMP) Plan. No pile-driving activity can commence prior to the Tidal Wetlands Division's approval of the Pile Driving BMP Plan. The Pile Driving BMP Plan shall be submitted for review and approval at least 30 days prior to the commencement of any pile driving activity authorized in this License. The Licensee shall implement and comply with the Pile Driving BMP Plan, which will detail support for the implementation of appropriate practices to protect water quality, marine life, and estuarine habitat, and include the use of zones of safe fish passage, soft starts, the use of a vibratory hammer, and the quantity of pile driving hours per day. The Pile Driving BMP Plan can only be modified upon approval by the Tidal Wetlands Division.
- H. The Licensee shall not allow debris to enter the waterway. The Licensee shall immediately remove all debris inadvertently introduced into the waterway as a result of any construction activity. Debris shall be reused where possible and approved by the Department or disposed of at an upland (nonwetland) disposal site and in a manner that does not adversely impact surface or subsurface waterflow into or out of tidal wetlands.
- I. Sediment and erosion control plans and stormwater management plans approved by MDE shall be submitted to MDE for approval prior to initiation of work in regulated areas. All work shall be performed in accordance with the required Soil Erosion and Sediment Control Plan as approved by MDE. Runoff or accumulated water containing sediment or other suspended materials shall not be discharged into waters of the State unless treated by an approved sediment control device or structure. Any proposed changes to approved sediment and erosion control plans or stormwater management plans during construction shall be forwarded to the approving authority for approval prior to implementation.
- J. If the project requires any on-site facility that requires a General Discharge Permit application, the Licensee shall apply to the Water and Science Administration, Industrial Discharge Permits Division, for review and approval, as determined necessary, prior to the commencement of work. The Licensee shall send confirmation to the Tidal Wetlands Division.
- K. The Licensee shall apply to the Land Management Administration, Land Restoration Program (LRP) for review and approval of the High Head Industrial Basin DMCF. The Licensee shall send the approved LRP Plan to the Tidal Wetlands Division prior to the commencement of construction.
- L. The Licensee shall apply to the Water and Science Administration, Wastewater Pollution Prevention & Reclamation Program for review and approval of a NPDES Permit modification as required, to include the discharge related to the High Head Industrial Basin DMCF. The Licensee shall send the approved LRP Plan to the Tidal Wetlands Division prior to the commencement of construction.
- M. Turbidity Monitoring Plan: No work authorized in this License can commence prior to the Tidal Wetlands Division's approval of the Turbidity Monitoring Plan. The Turbidity Monitoring Plan shall be submitted for review and approval at least 30 days prior to the commencement of any work authorized in this License. The Licensee shall implement and

comply with the Turbidity Monitoring Plan, which will detail support for the implementation of appropriate practices to protect water quality, marine life, and estuarine habitat, and include testing/monitoring turbidity related to dredging, shoreline stabilization activity, and outfalls. It will provide benchmarks and corrective actions if those benchmarks are exceeded. The Turbidity Monitoring Plan can only be modified upon approval by the Tidal Wetlands Division.

- N. The Licensee shall design and construct the stone or concrete revetment to prevent the loss of fill material to waters of the State of Maryland.
- O. The Licensee shall not use asphalt rubble in the revetment. Prior to the emplacement of the revetment, all rebar is to be cut off flush with the concrete. After emplacement of the revetment, any rebar exposed as a result of the concrete breaking during the emplacement is to be cut flush with the concrete. Except for the larger material placed along the leading edge of the revetment, the concrete shall be broken prior to emplacement so that random sized interlocking pieces are formed.
- P. A pre-construction meeting shall be held with the Maryland Department of the Environment Compliance Program, Maryland Board of Public Works, the US Army Corps of Engineers (Baltimore Regional Office), and other agency stakeholders to provide the opportunity for all to review and discuss the construction plans and conditions. All meeting participants shall be notified of this meeting a minimum of 14 days prior to the date of the meeting.
- Q. A professional engineer (PE), registered in the State of Maryland and qualified in dike and design and construction, shall be designated as the Engineer in Charge (EIC) and supervise the construction of the dike walls for the High Head Industrial Basin DMCF.
- R. Prior to the DMCF operation and receipt of the dredged material, the EIC shall provide a completed "Dike Completion Report" to the Tidal Wetlands Division within sixty (60) days following construction of the DMCF dike to the final design elevation. The Report shall provide a project history, as-built drawings, and certify to the Tidal Wetlands Division that the dike is structurally sound and is ready to receive dredged material.
- S. Stormwater discharges shall have a velocity no greater than four feet per second for the two-year storm in order to prevent erosion in the receiving waterway or wetland.
- T. Mitigation Plan: Mitigation is required for 3.08 acres of impact related to the permanent fill placed in State tidal wetlands in accordance with COMAR 26.24. The Licensee shall submit a Mitigation Plan to the Tidal Wetlands Division and the Wetlands Administrator within 90 days following approval of this State wetlands license. Upon approval of the Mitigation Plan, if the Tidal Wetlands Division determines that a Joint Permit Application (JPA) is required, the Licensee shall submit a JPA within 30 days following the Tidal Wetlands Division's determination. The Licensee shall implement the mitigation plan in accordance with the approved plan and schedule. The Mitigation Plan can only be modified upon approval by the Tidal Wetlands Division.
- U. The Licensee shall remove the DMCF discharge structure, which includes the 24-inch diameter pipe extension and diffuser prior to the expiration of this License. If dewatering activity exceeds the expiration date of this License, the Licensee shall submit a JPA to the Tidal Wetlands Division at least 30 days prior to the expiration of the License for the removal of the temporary structures.

THIS LICENSE AUTHORIZES YOU TO PERFORM THE WORK ONLY IF YOU COMPLY WITH THE FOLLOWING STANDARD CONDITIONS:

- 1. Licensee shall conduct the authorized work in accordance with the plans and drawings dated as accepted by MDE on June 5, 2025, which are hereby incorporated into this License.
- 2. Until the authorized work is complete, Licensee shall have available at the site a copy of this License including the plans and drawings.
- 3. This License constitutes Maryland's authorization to conduct the authorized work under the State Tidal Wetlands Law. This License does not bestow any other federal, State, or local government authorization.
- 4. Licensee shall have all proposed work above Mean High Water reviewed and authorized by the local county Department of Planning and Zoning or applicable agency.
- 5. Licensee shall notify MDE's Compliance Program by BOTH phone AND in writing of the following:
 - (a) start date at least five business days before beginning work; and
 - (b) completion date no more than five business days after project completion. Central Division: 410-537-3510 1800 Washington Blvd, Baltimore, MD 21230
- 6. Licensee shall comply with any regulations, conditions, or instructions issued by MDE, including any Water Quality Certification issued with respect to the authorized work.
- 7. Licensee shall conduct the authorized work in accordance with Critical Area Commission requirements. This License does not authorize disturbance in the Buffer. If authorized work will disturb the Buffer, Licensee shall have a Commission-approved or locally approved Buffer Management Plan before beginning the authorized work. "Buffer" means the 100-foot Critical Area Buffer and any expanded area that is immediately landward of the mean high-water line of the tidal waters or is immediately landward of tidal wetlands. The Buffer includes expanded contiguous area if the contiguous area includes steep slopes, hydric soil, or highly erodible soil, or otherwise meets the criteria of COMAR 27.01.09.01.E(7). "Disturbance" means any alteration or change to the land including any amount of clearing. Clearing includes vegetation removal, grading, and construction activity.
- 8. Licensee may not fill, dredge, or otherwise alter or destroy tidal marsh or its vegetation unless this License specifically authorizes the activity.
- 9. Licensee may not stockpile material in State tidal wetlands/State tidal waters of the U.S.
- 10. Licensee shall allow unfettered public use of State wetlands/State tidal waters of the U.S.
- 11. This License does not transfer a property interest of the State.
- 12. Licensee shall file a Miss Utility ticket for the proposed work at least 10 days before beginning work. *Miss Utility*: 800-257-7777
- 13. Licensee shall ensure that structures (for example, piers and piles) removed from the site are taken to an upland disposal facility approved by MDE's Compliance Program.
- 14. If the authorized work impacts more than 5,000 square feet or includes 100 or more cubic yards of fill, Licensee shall conduct the authorized work in accordance with a locally approved Soil Erosion and Sediment Control Plan.
- 15. If the authorized work is not performed by the property owner, all work performed under this Tidal Wetlands License shall be conducted by a marine contractor licensed by the Marine Contractors Licensing Board (MCLB) in accordance with Title 17 of the Environment Article of Annotated Code of Maryland. A list of licensed marine contactors may be obtained by contacting the MCLB at 410-537-3249, by email at

MDE.MCLB@maryland.gov or by accessing the Maryland Department of the Environment, Environmental Boards webpage.

- 16. Licensee shall allow State officials and employees to make inspections at reasonable times and cooperate with those inspections.
- 17. This License is granted only to the Licensee. Licensee may transfer the license only with written approval from the Board of Public Works. If the Board of Public Works approves the transfer, the transferee is subject to all License terms and conditions.
- 18. Licensee shall indemnify, defend, and save harmless the State of Maryland, its officials, officers, and employees from and against any and all liability, suits, claims, and actions of whatever kind, caused by or arising from, the work this License authorizes.
- 19. The Board of Public Works or its Wetlands Administrator may modify, suspend, or revoke this License in its reasonable discretion. Licensee shall promptly comply upon notice of any such action.

 September 10, 2031.
- 20. This License expires

If the authorized work is not completed by the expiration date, all activity must stop.

Note: A three-year license may be renewed for one additional three-year term if the

Licensee requests an extension before the expiration date and all other conditions are met. A six-year license may not be renewed; instead, Licensee must reapply to MDE for a new license. Contact the Board of Public Works to determine if this License may be extended. *Board of Public Works:* 410-260-7791

- 21. In conducting work authorized under this license, licensee may not cause injury to private property; invade the rights of others; or infringe any federal, state, or local laws or regulations.
- 22. Licensee shall maintain any authorize structure in good condition and perform the authorized activity in a workmanlike manner in accordance with this license.
- 23. In conducting work authorized under this license, licensee shall eliminate or minimize adverse effects on fish, wildlife, and the natural environment.

By the authority of the Board of Public Works:

William Morgante
William Morgante

Wetlands Administrator

September 10, 2025

Effective Date:


Approved as: Secretary's Agenda Item 7

Board of Public Works Meeting Date: August 27, 2025

I accept this License and all	ITS CONDITIONS. Signed by:
9/4/2025	terry Doyle
Date	Licensee (Signature)
	Kerry Doyle
	Name (Printed)
	Managing Director
	Title
	kdoyle@tradepointatlantic.com
	Email (to receive completed license)





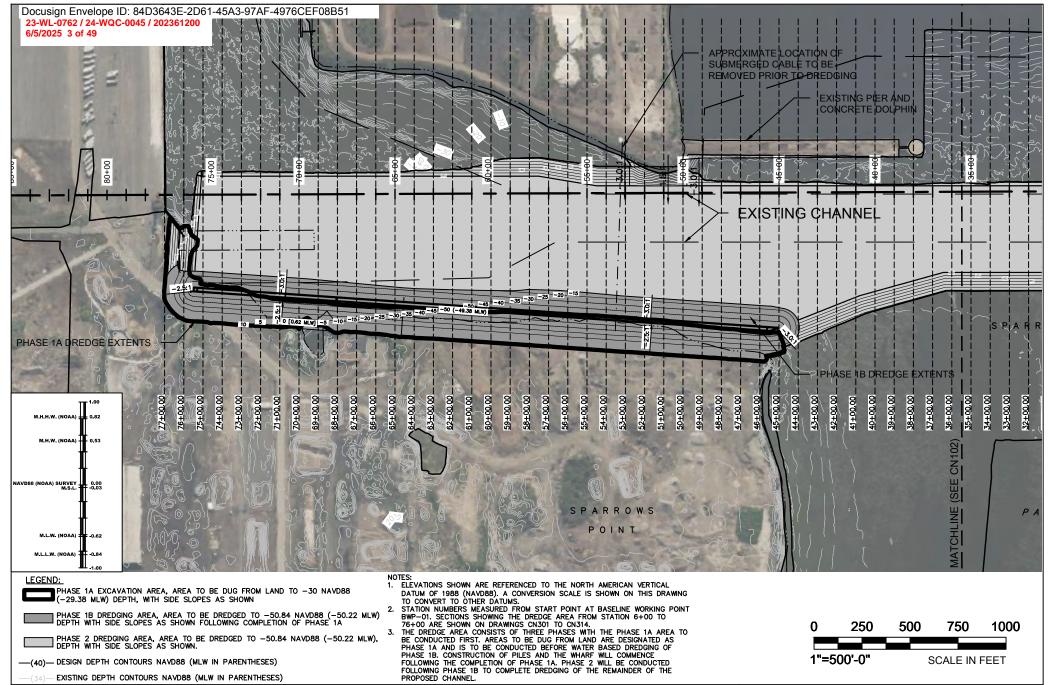

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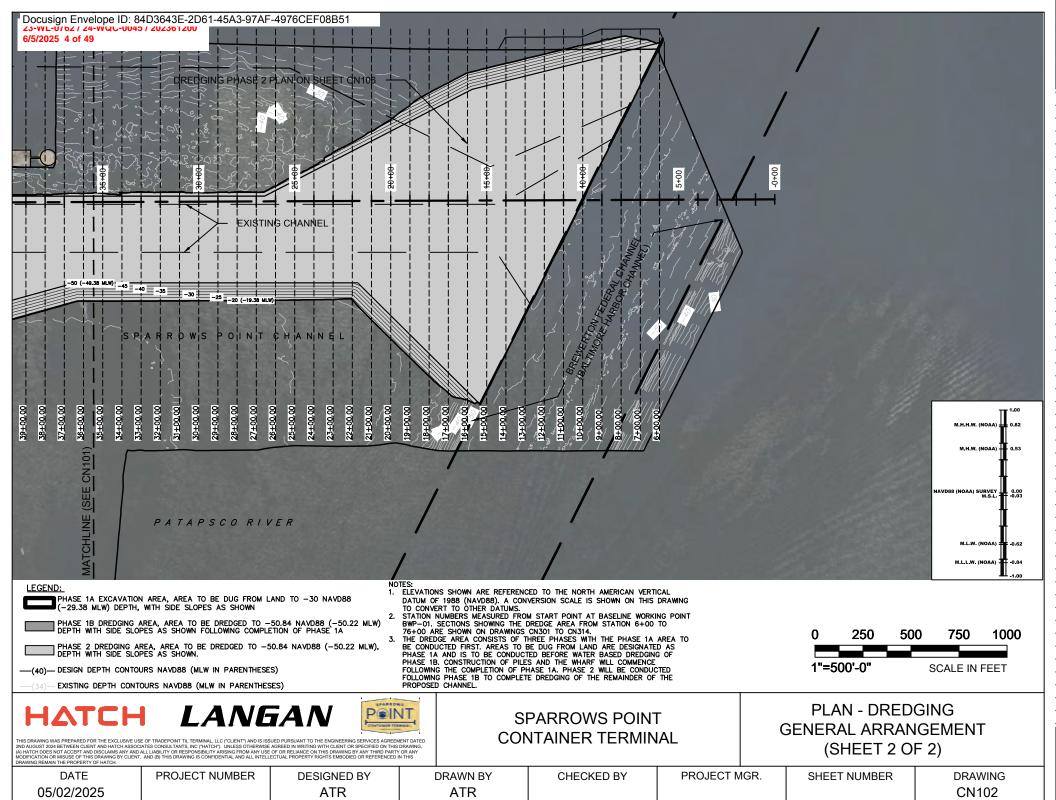
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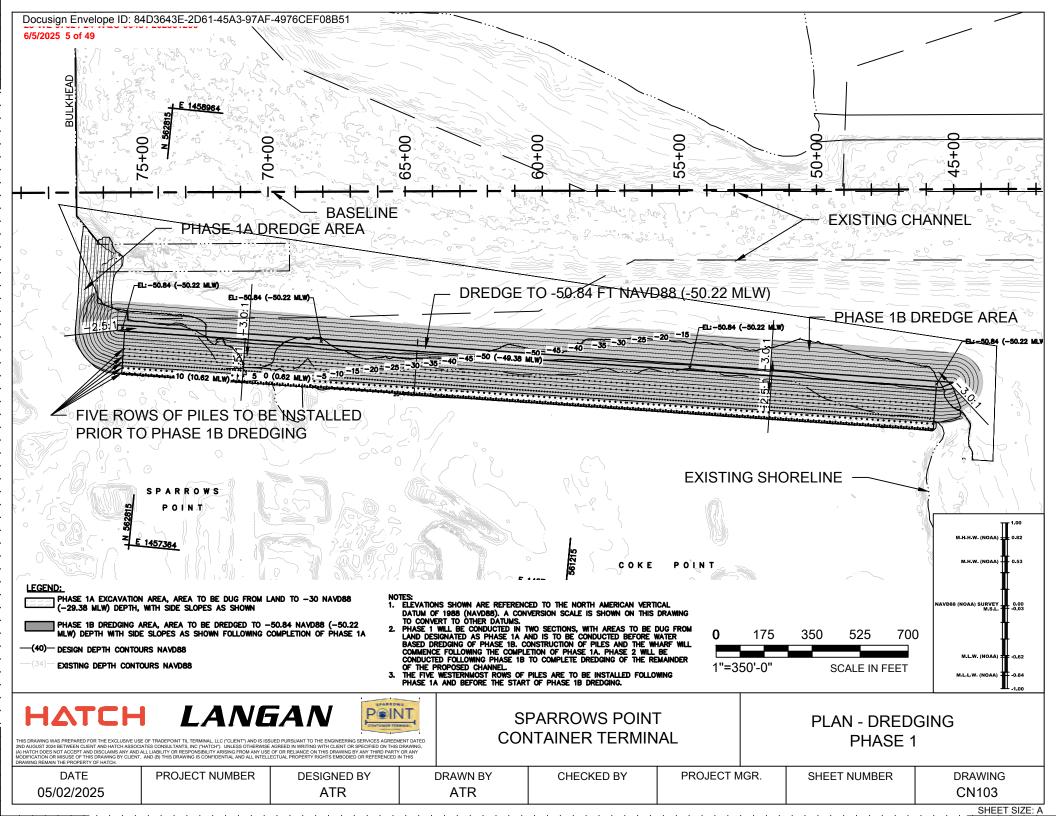
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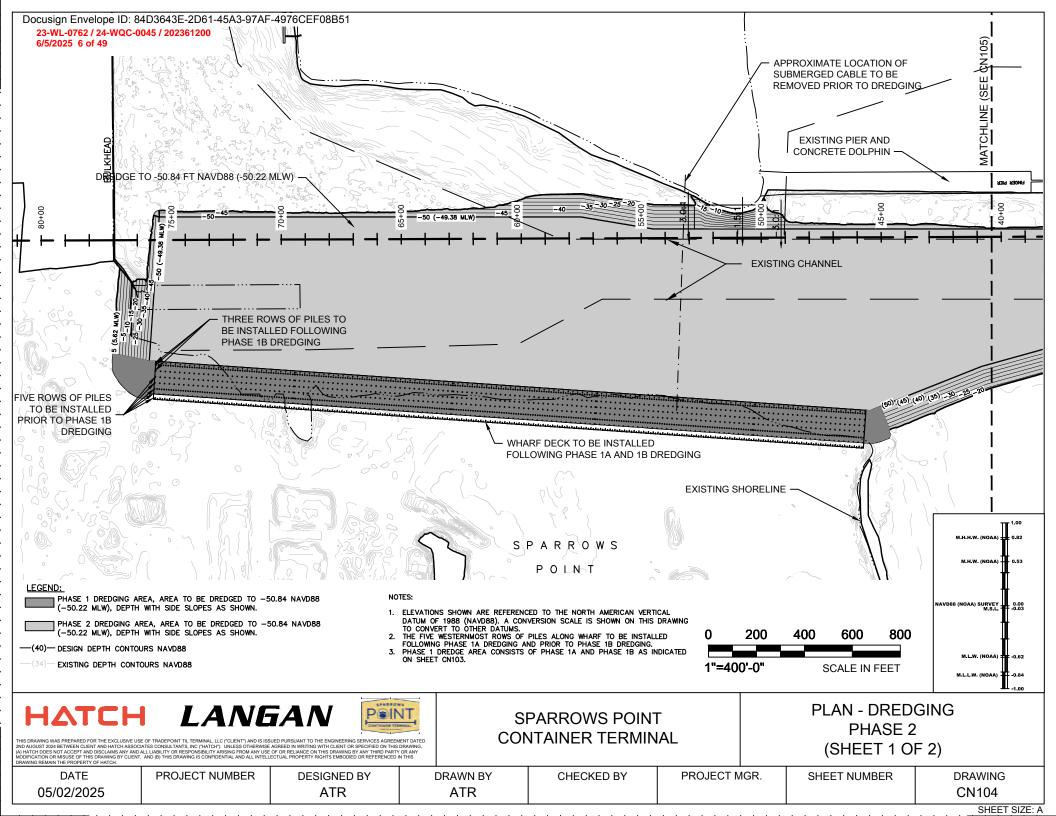
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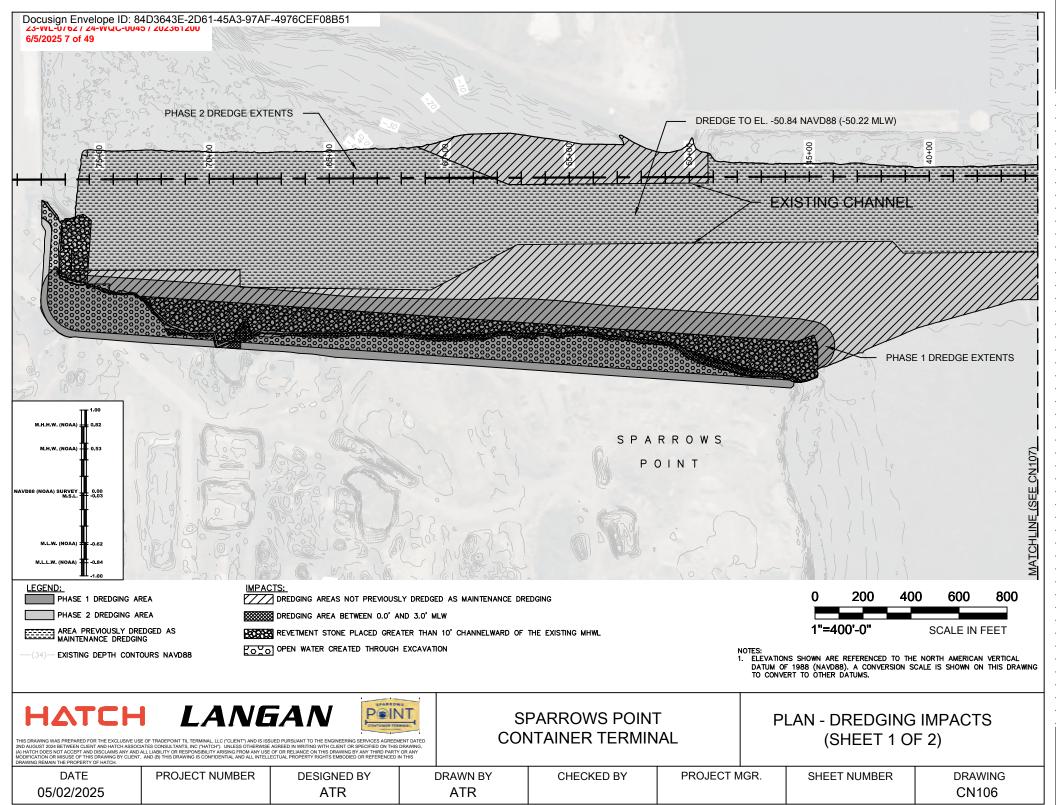
PLAN - DREDGING GENERAL ARRANGEMENT (SHEET 1 OF 2)


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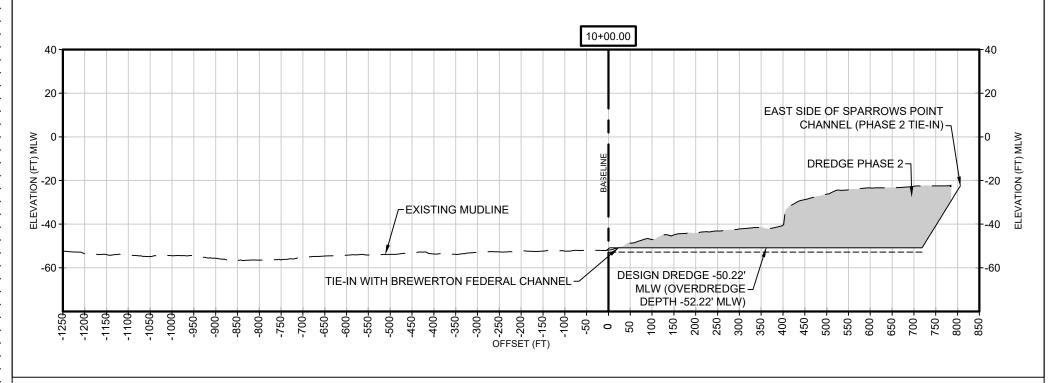











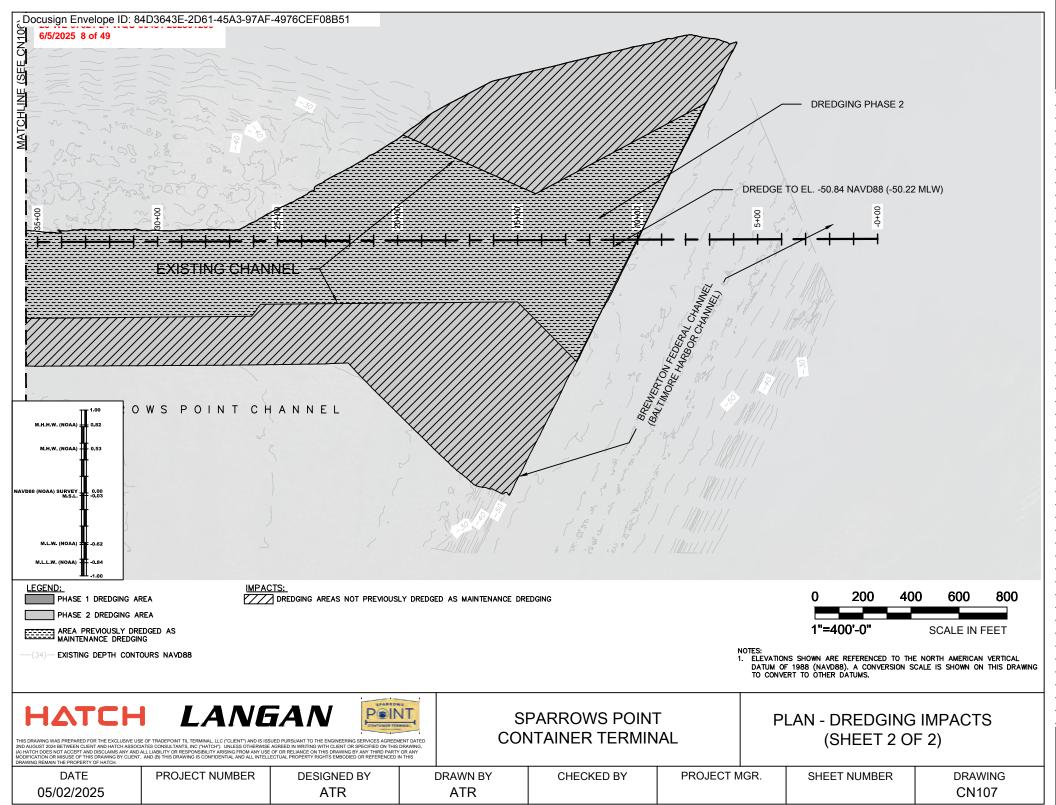

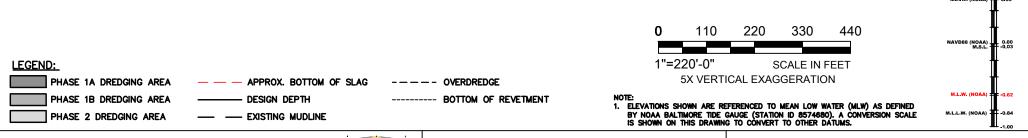

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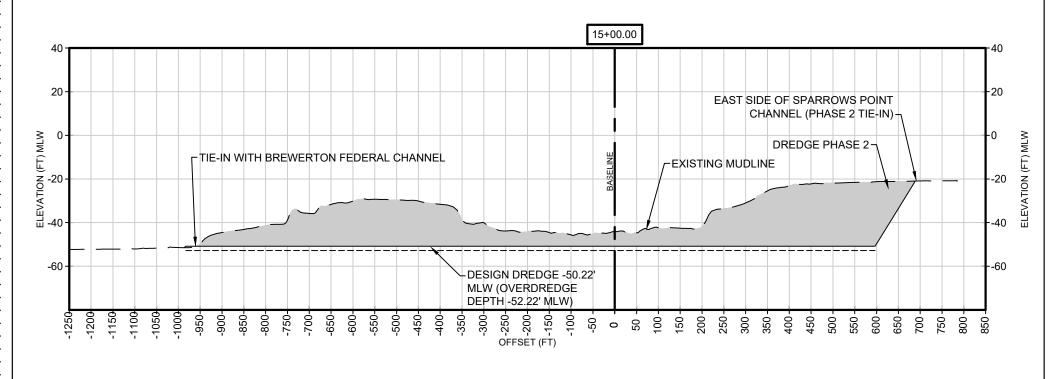
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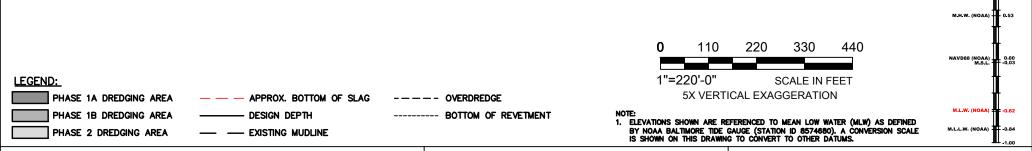


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SECTIONS - DREDGING (SHEET 1 OF 14)

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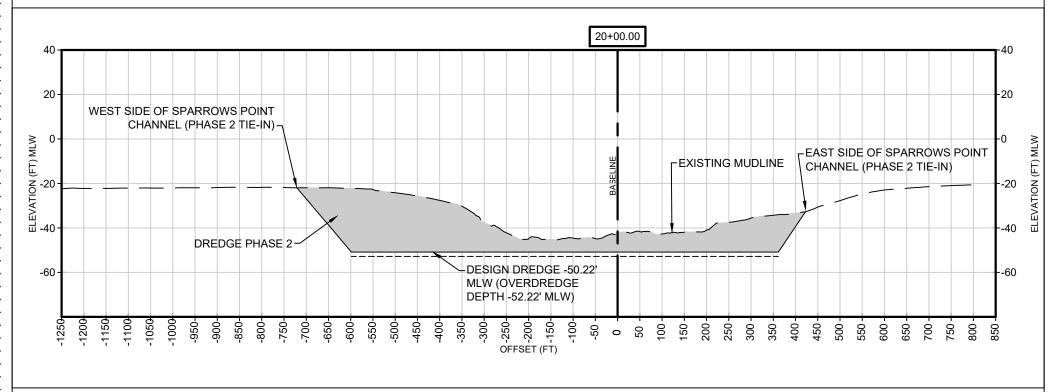
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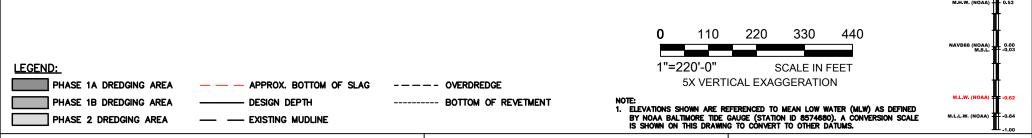


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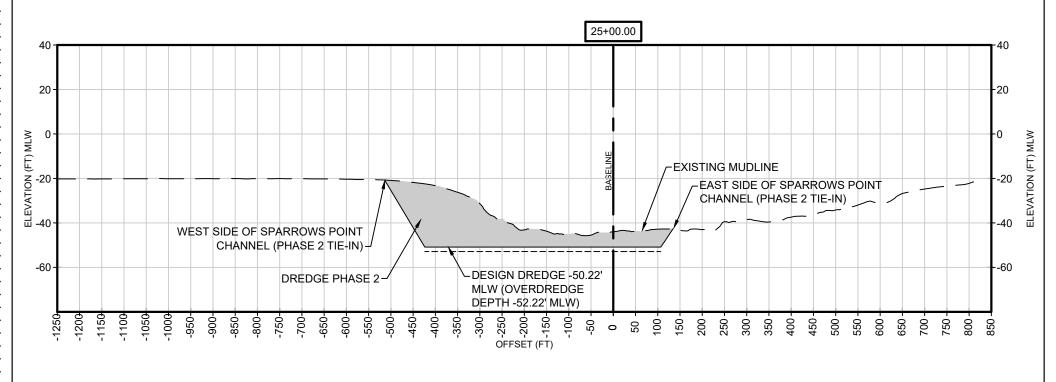
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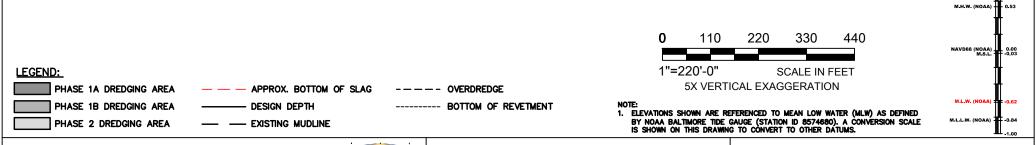


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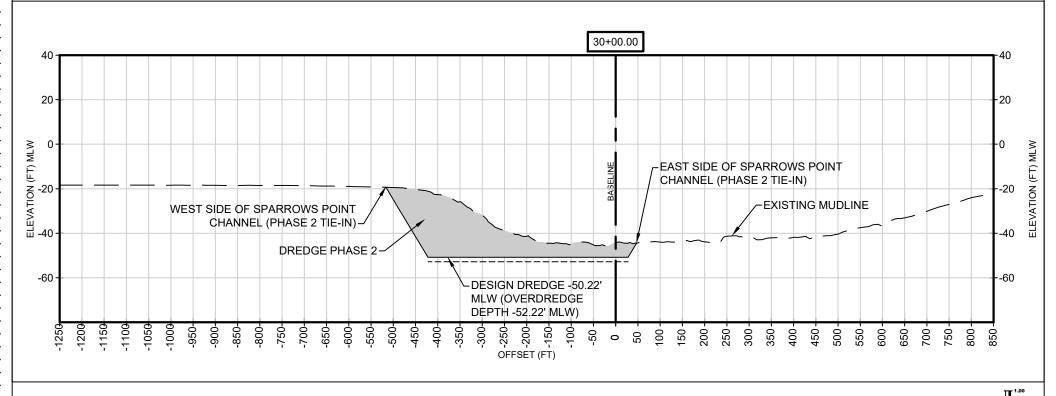
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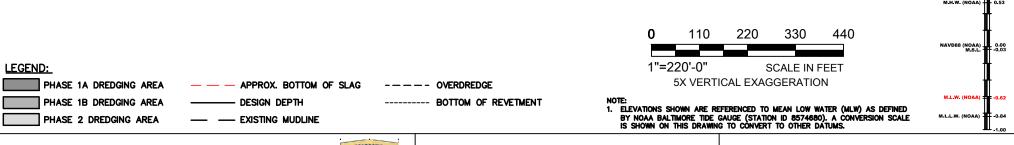


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SECTIONS - DREDGING (SHEET 4 OF 14)

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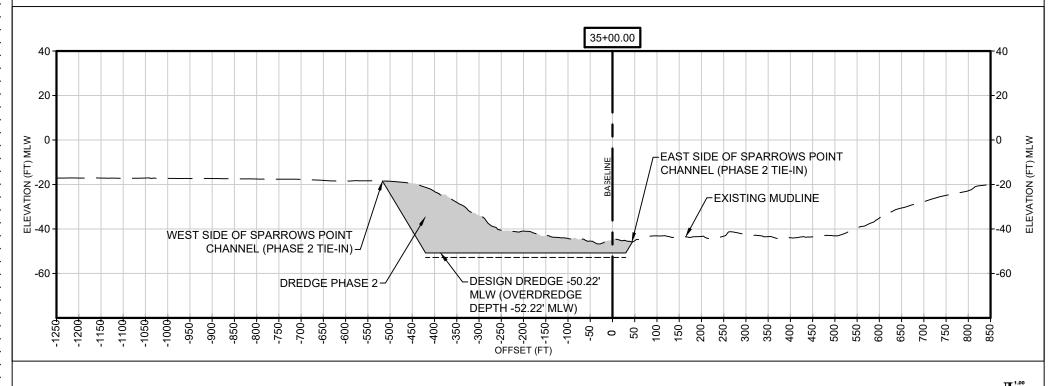
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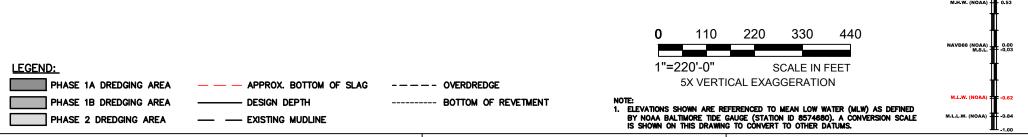


SPARROWS POINT CONTAINER TERMINAL

SECTIONS - DREDGING (SHEET 5 OF 14)

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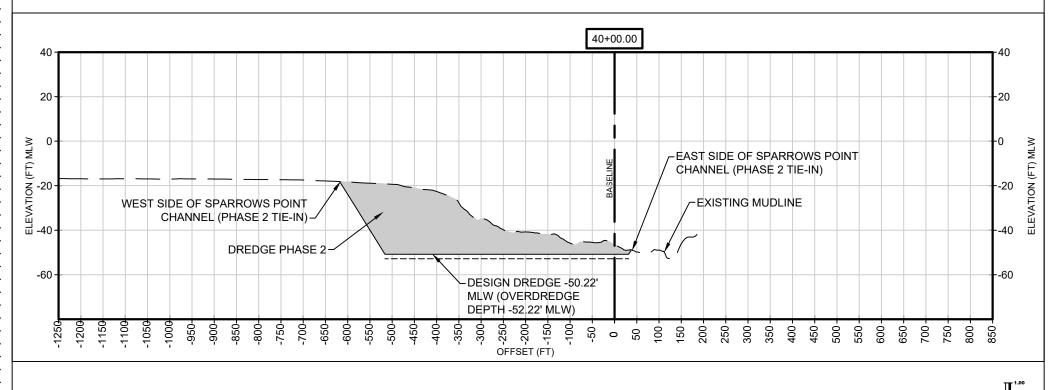



SPARROWS POINT CONTAINER TERMINAL

SECTIONS - DREDGING (SHEET 6 OF 14)

2ND AUGUST 2024 BETWEEN CLIENT AND HATCH ASSOC (A) HATCH DOES NOT ACCEPT AND DISCLAIMS ANY AND	EATER CONSULTANTS, INC ("HATCH"). UNLESS OTHERWISE ALL LIABILITY OR RESPONSIBILITY ARISING FROM ANY USE AND (B) THIS DRAWING IS CONFIDENTIAL AND ALL INTELL	AGREED IN WRITING WITH CLIENT OR SPECIFIED ON THIS OF OR RELIANCE ON THIS DRAWING BY ANY THIRD PARTY	DRAWING, OR ANY			(61.221.6.61.1)			
DATE 05/02/2025	PROJECT NUMBER	DESIGNED BY ATR	DRAWN BY ATR	CHECKED BY	PROJECT MGR.	SHEET NUMBER	DRAWING CN306		

Docusign Envelope ID: 84D3643E-2D61-45A3-97AF-4976CEF08B51 23-WL-0762 / 24-WQC-0045 / 202361200 6/5/2025 15 of 49



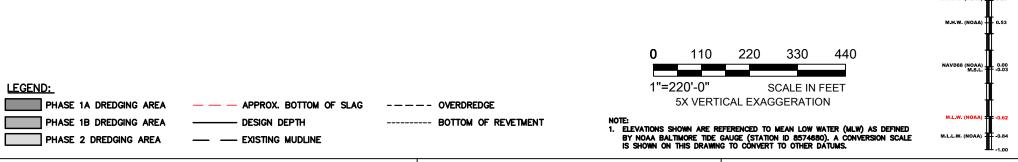

HATCH

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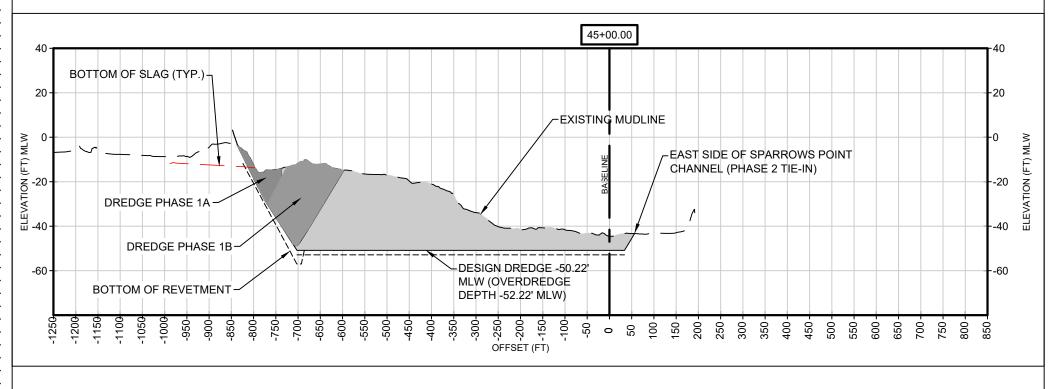
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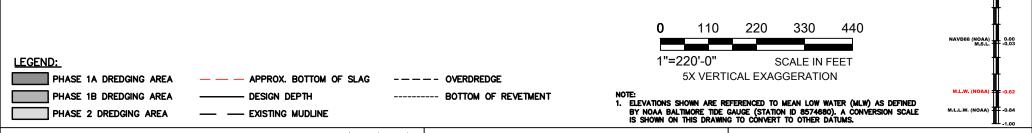


SPARROWS POINT CONTAINER TERMINAL

SECTIONS - DREDGING (SHEET 7 OF 14)

DRAWING REMAIN THE PROPERTY OF HATCH.							
DATE	PROJECT NUMBER	DESIGNED BY	DRAWN BY	CHECKED BY	PROJECT MGR.	SHEET NUMBER	DRAWING
05/02/2025		ATR	ATR				CN307






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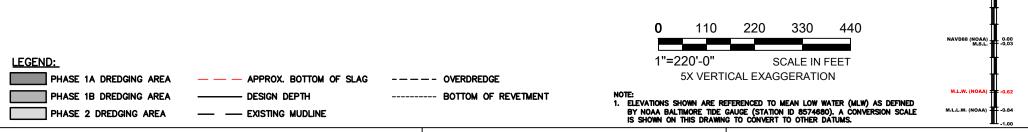


SPARROWS POINT CONTAINER TERMINAL

SECTIONS - DREDGING (SHEET 8 OF 14)

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DATE	PROJECT NUMBER	DESIGNED BY	D	RAWN BY	CHECKED BY PROJECT I	PROJECT M	GR.	SHEET NUMBER	DRAWING
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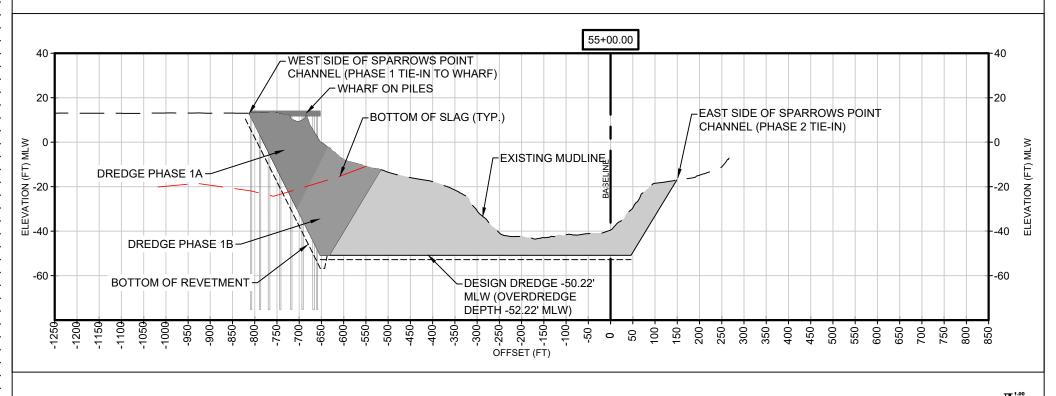
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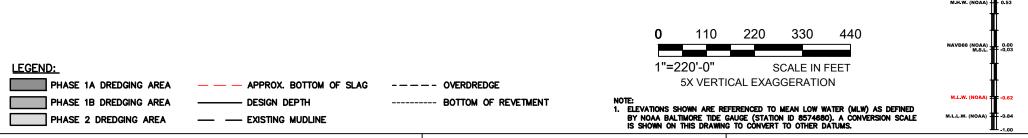


SPARROWS POINT CONTAINER TERMINAL

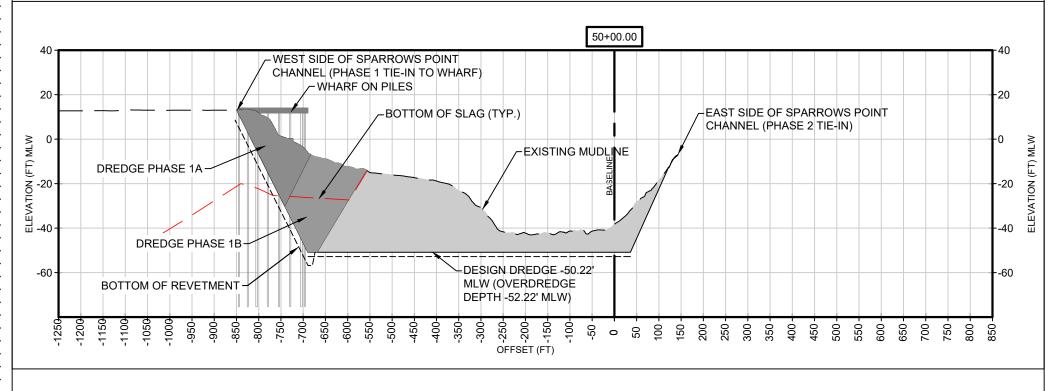SECTIONS - DREDGING (SHEET 9 OF 14)

DRAWING REMAIN THE PROPERTY OF HATCH.							
DATE	PROJECT NUMBER	DESIGNED BY	DRAWN BY	CHECKED BY	PROJECT MGR.	SHEET NUMBER	DRAWING
05/02/2025		ATR	ATR				CN309





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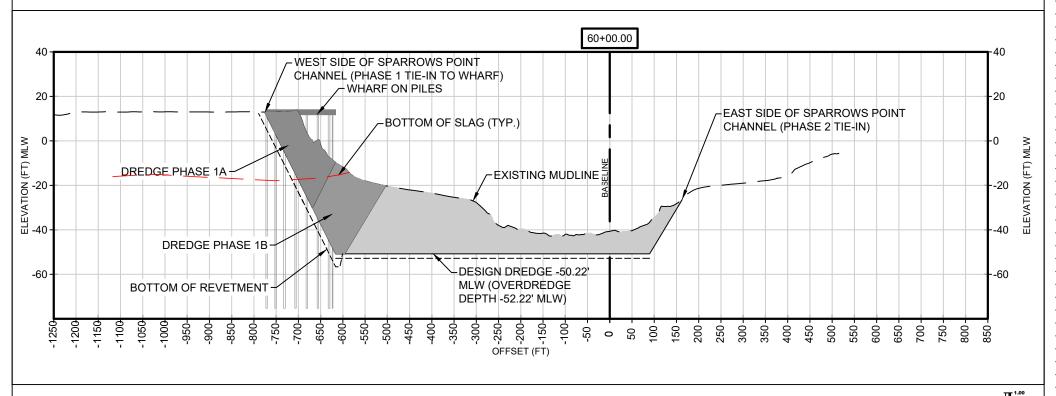
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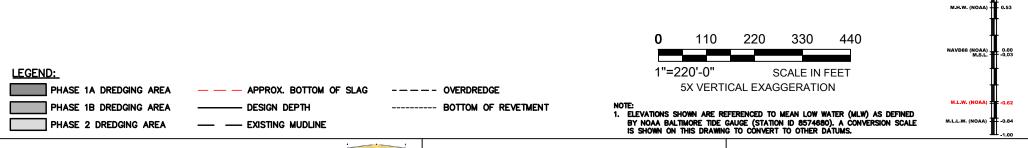


SPARROWS POINT CONTAINER TERMINAL

SECTIONS - DREDGING (SHEET 10 OF 14)

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05/02/2025		ATR	ATR				CN310






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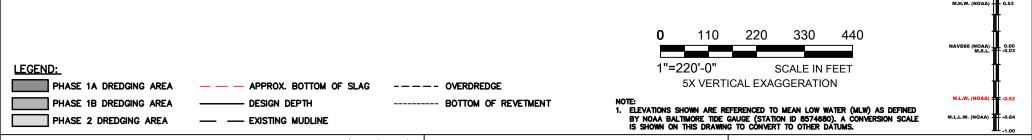


SPARROWS POINT CONTAINER TERMINAL

SECTIONS - DREDGING (SHEET 11 OF 14)

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05/02/2025		ATR		ATR					CN311



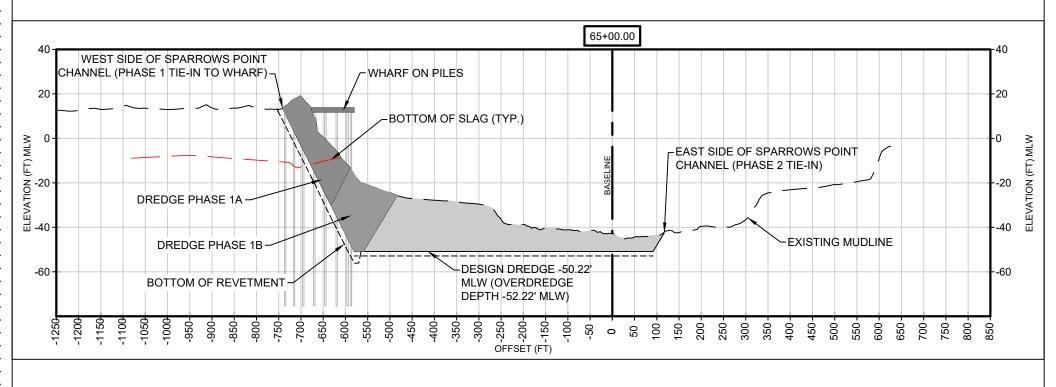


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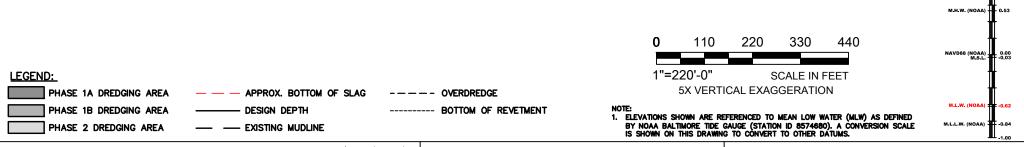


SPARROWS POINT CONTAINER TERMINAL

SECTIONS - DREDGING (SHEET 12 OF 14)

200 AUGUST 200 SETWEEN CLIENT AND INATCH ASSOCIATES CONSULTANTS, INC ("NATCH"). UNLESS OTHERWISE AGREED IN WRITING WITH CLIENT OR SPECIFIED ON THIS DRAWNING. (A) HATCH ODES NOT ACCEPT AND DISCLAMES ANY AND ALL LUBBLUTY OR RESPONSIBILITY ARISING FROM ANY USE OF OR RELOOG ATHIS DRAWNING BY ANY THIRD PARTY OR ANY MODIFICATION OR MUSISE OF THIS DRAWNING BY CLIENT, AND (B) THIS DRAWNING BY CLIENT, AND (B) THIS DRAWNING BY CLIENT, AND (B) THIS DRAWNING BY CLIENT, AND ALL INTELLECTUAL PROPERTY RIGHTS EMBODIED OR REFERENCED IN THIS DRAWNING BY CLIENT, AND ALL INTELLECTUAL PROPERTY RIGHTS EMBODIED OR REFERENCED IN THIS DRAWNING BY CLIENT, OR AND ALL INTELLECTUAL PROPERTY RIGHTS EMBODIED OR REFERENCED IN THIS DRAWNING BY CLIENT, OR AND ALL INTELLECTUAL PROPERTY RIGHTS EMBODIED OR REFERENCED IN THIS DRAWNING BY CLIENT, OR AND ALL INTELLECTUAL PROPERTY RIGHTS EMBODIED OR REFERENCED IN THIS DRAWNING BY CLIENT, OR AND ALL INTELLECTUAL PROPERTY RIGHTS EMBODIED OR REFERENCED IN THIS DRAWNING BY CLIENT, OR AND ALL INTELLECTUAL PROPERTY RIGHTS EMBODIED OR REFERENCED IN THIS DRAWNING BY CLIENT, OR AND ALL INTELLECTUAL PROPERTY RIGHTS EMBODIED OR REFERENCED IN THIS DRAWNING BY CLIENT, OR AND ALL INTELLECTUAL PROPERTY RIGHTS EMBODIED OR REFERENCED IN THIS DRAWNING BY CLIENT, OR AND ALL INTELLECTUAL PROPERTY RIGHTS EMBODIED OR REFERENCED IN THIS DRAWNING BY CLIENT, AND ALL INTELLECTUAL PROPERTY RIGHTS EMBODIED OR REFERENCED IN THIS DRAWNING BY CLIENT, AND ALL INTELLECTUAL PROPERTY RIGHTS EMBODIED OR REFERENCED IN THIS DRAWNING BY CLIENT, AND ALL INTELLECTUAL PROPERTY RIGHTS EMBODIED OR REFERENCED IN THIS DRAWNING BY CLIENT, AND ALL INTELLECTUAL PROPERTY RIGHTS EMBODIED OR REFERENCED IN THIS DRAWNING BY CLIENT, AND ALL INTELLECTUAL PROPERTY RIGHTS EMBODIED OR REFERENCED IN THIS DRAWNING BY CLIENT, AND ALL INTELLECTUAL PROPERTY RIGHTS EMBODIED OR REFERENCED IN THIS DRAWNING BY CLIENT, AND ALL INTELLECTUAL PROPERTY RIGHTS AND			DRAWING, Y OR ANY	CONTINUE (CITED IN 1)				
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	05/02/2025		ATR	ATR				CN312



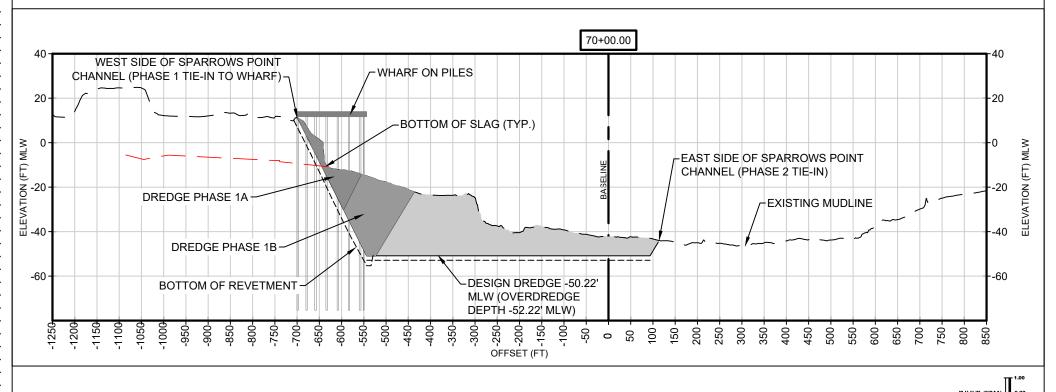

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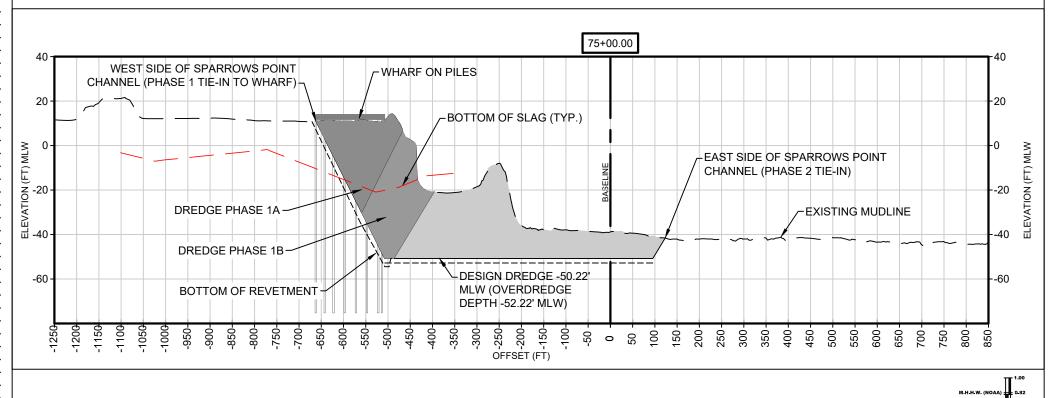
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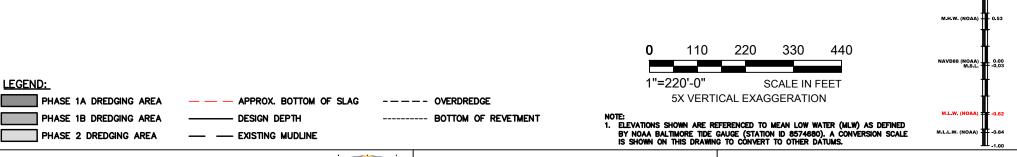


SPARROWS POINT CONTAINER TERMINAL

SECTIONS - DREDGING (SHEET 13 OF 14)

DRAWING REMAIN THE PROPERTY OF HATCH.							
DATE	PROJECT NUMBER	DESIGNED BY	DRAWN BY	CHECKED BY	PROJECT MGR.	SHEET NUMBER	DRAWING
05/02/2025		ATR	ATR				CN313





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2ND AUGUST 2024 BETWEEN CLIENT AND HATCH ASSOCIATES CONSULTANTS, INC ("HATCH"). UNLESS OTHERWISE AGREED IN WRITING WITH CLIENT OR SPECIFIED ON THIS DRAWING, (A) HATCH DOES NOT AGED THAN DISCAUMEN ANY AND ALL LIABILITY OR RESPONSIBILITY ARISING FROM MAY USE OF OR RELIANCE ON THIS DRAWING BY CLIENT, AND (B) THIS DRAWING BY CURLEDITUAL AND ALL INTELLECTULE, PROPERTY RICHTS EMBOORD OR REFERENCE IN THIS



SPARROWS POINT CONTAINER TERMINAL

SECTIONS - DREDGING (SHEET 14 OF 14)

DRAWING REMAIN THE PROPERTY OF HATCH.							
DATE	PROJECT NUMBER	DESIGNED BY	DRAWN BY	CHECKED BY	PROJECT MGR.	SHEET NUMBER	DRAWING
05/02/2025		ATR	ATR				CN314

DREDGING IMPACTS SUMMARY SPARROWS POINT CHANNEL

PROPOSED DREDGE QUANTITIES	
Proposed Total Dredge Footprint (SF)	5,907,855
Proposed Total Dredge Footprint (Acres)	135.63
Previously Permitted Maintenance Dredge Footprint (SF)	2,925,513
Previously Permitted Maintenance Dredge Footprint (Acres)	67.16
Proposed Dredge Footprint Not Previously Maintained as Maintenance Dredging (SF)	2,705,013
Proposed Dredge Footprint Not Previously Maintained as Maintenance Dredging (Acres)	62.10
Proposed Dredge Volume (CY)	4,200,000
Open Water Created Through Excavation (SF)	277,329
Open Water Created Through Excavation (Acres)	6.37
Proposed Dredge Footprint Between MHW and -3 MLW (SF)	65,527
Proposed Dredge Footprint Between MHW and -3 MLW (Acres)	1.50
Excavation Volume (CY)	133,361







SPARROWS POINT CONTAINER TERMINAL **DREDGING IMPACTS SUMMARY**

DATE 05/23/2025 PROJECT NUMBER

DESIGNED BY ATR

DRAWN BY ATR

CHECKED BY

PROJECT MGR.

SHEET NUMBER

DRAWING CN100


6/5/2025 24 of 49

SPARROWS POINT CONTAINER TERMINAL WHARF

SHORELINE IMPACT

BALTIMORE COUNTY, MARYLAND



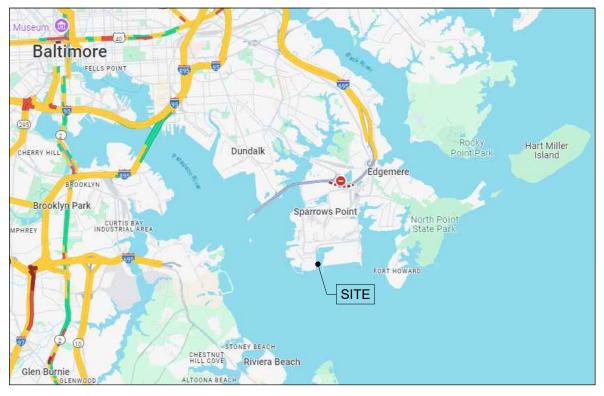

LIST OF DRAWINGS:

DRAWING NO.	SHEET	DRAWING TITLE
0001	1	TITLE SHEET
0002	2	GENERAL ARRANGEMENT
CN108		NORTH OF WHARF
0003	3	WHARF PLAN SHEET 1 OF 2
0004	4	WHARF PLAN SHEET 2 OF 2
CN109		SOUTH OF WHARF
0005	5	INTENTIONALLY OMITTED
0006	6	SECTION
0007	7	SECTION
0008	8	SECTION
0009	9	SECTION
0040	40	IMPACT





SPARROWS POINT **CONTAINER TERMINAL** WHARF

BALTIMORE COUNTY, MARYLAND

TITLE SHEET

DATE 25/0 -. 4


PROJECT NUMBER H374437


DESIGNED BY SARA SHATZ


DRAWN BY TIM DONOVAN **CHECKED BY** SARA SHATZ


PROJECT MGR. JOSHUA NELSON SHEET NUMBER 1 OF 10


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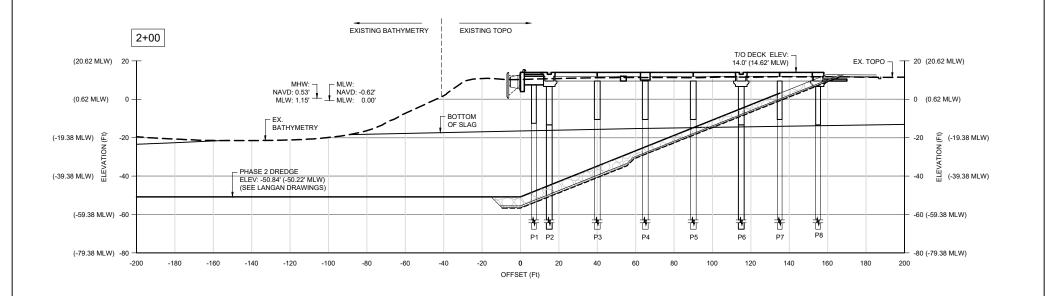


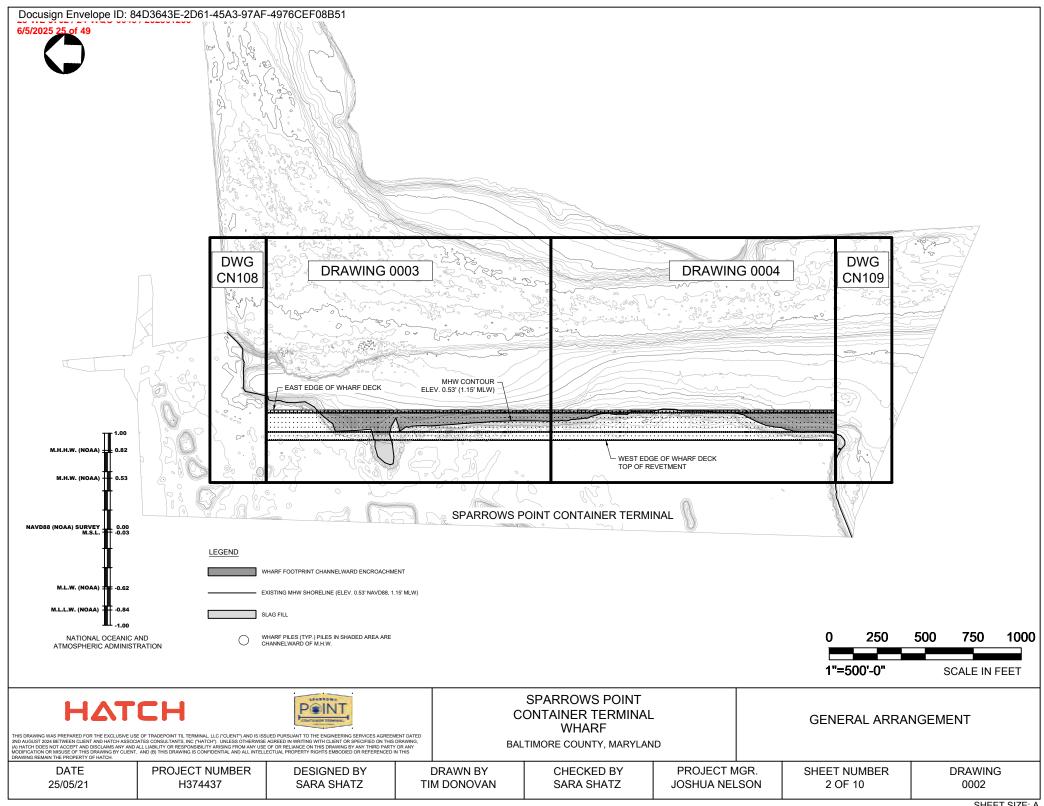


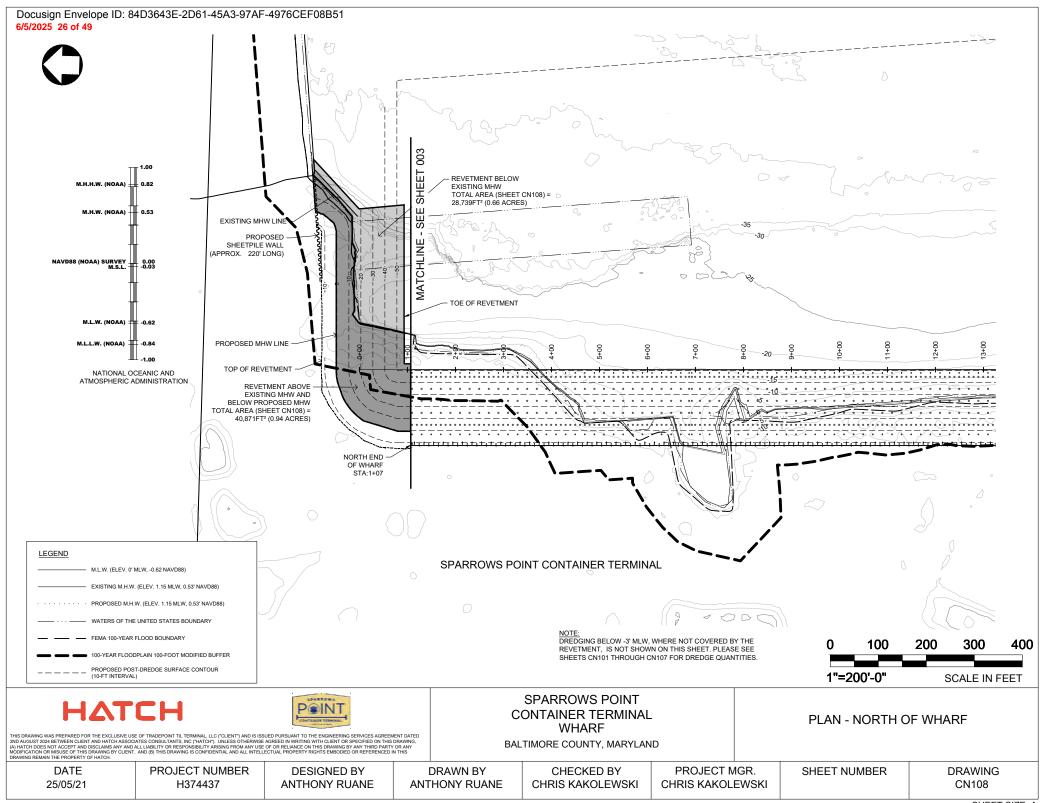

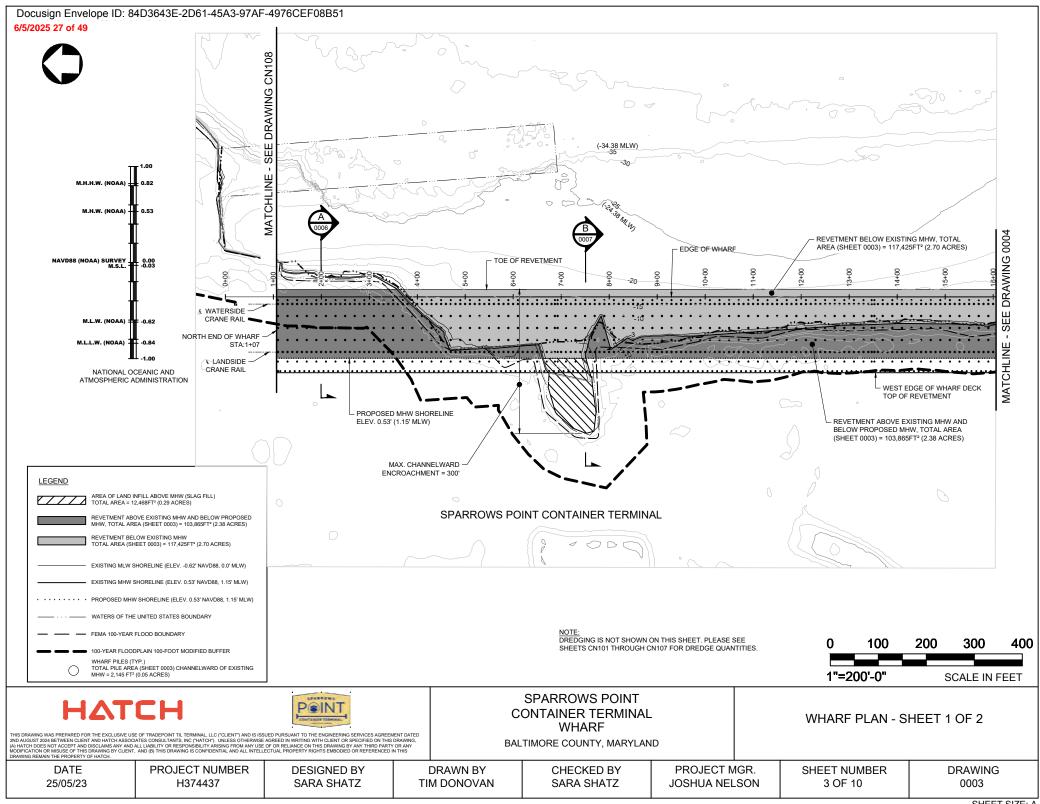

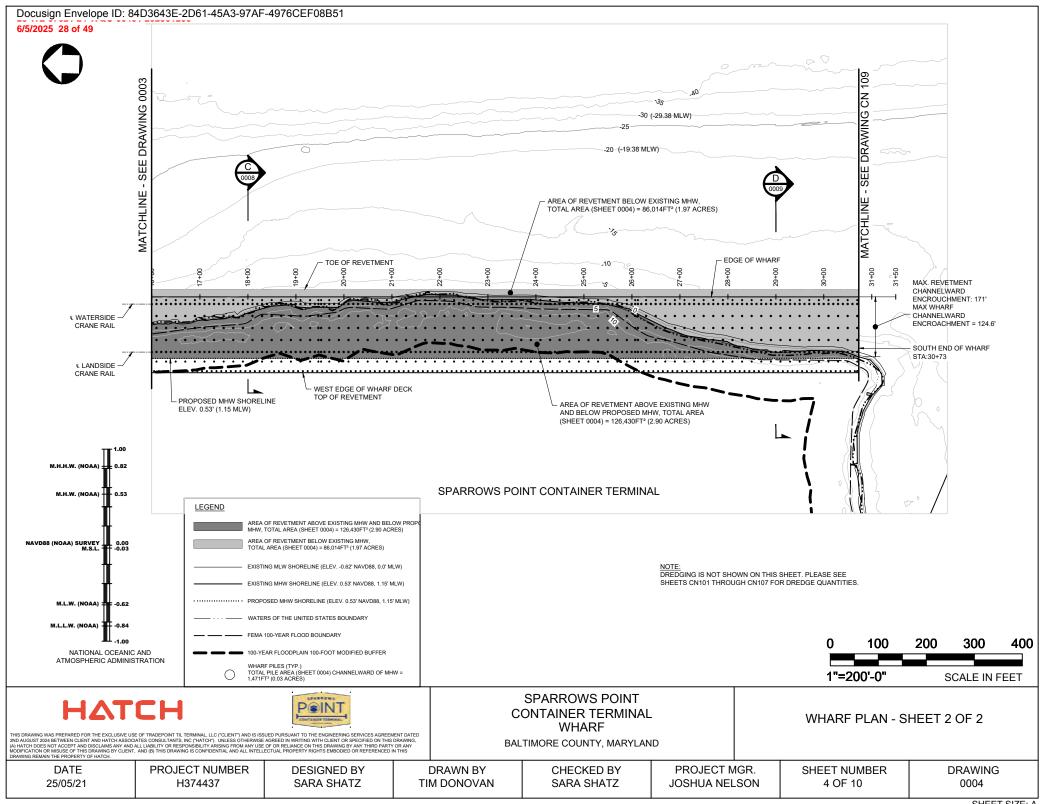

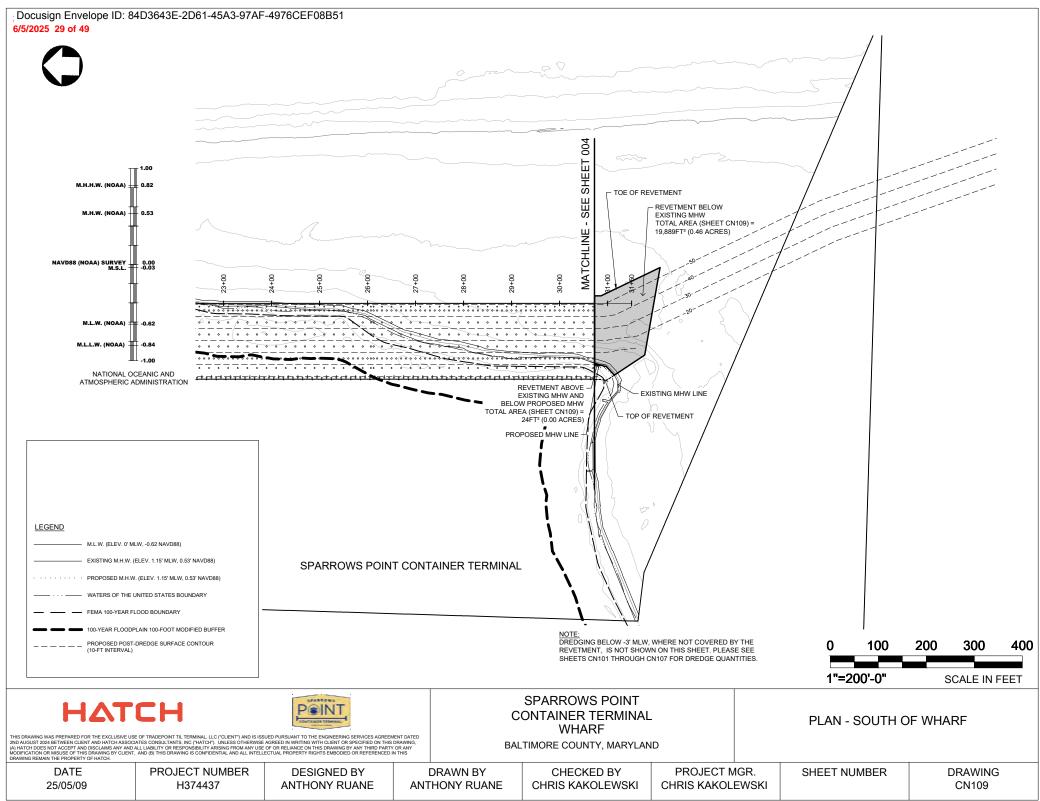

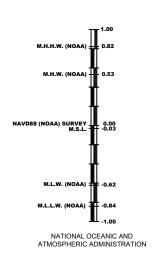

PILE LEGEND:

P1 = Ø30" STEEL CANTILEVER PILE (20' SPACING) P2 = Ø36" STEEL CRANE RAIL PILE (10' SPACING) P3 = Ø36" STEEL DECK PILE (20' SPACING) P4 = Ø36" STEEL DECK PILE (20' SPACING) P5 = Ø36" STEEL DECK PILE (20' SPACING) P6 = Ø36" STEEL CRANE RAIL PILE (10' SPACING) P7 = Ø30" STEEL DECK PILE (20' SPACING) P8 = Ø30" STEEL PILE (10' SPACING)



25/05/05



SARA SHATZ

SPARROWS POINT CONTAINER TERMINAL WHARF BALTIMORE COUNTY, MARYLAND

SECTION

25

1"=50'-0"

50

75

SCALE IN FEET

100

THIS DRAWING WAS PREPARED FOR THE EXCLUSIVE USE OF TRADEPOINT TIL TERMINAL, LLC ("CLIENT") AND IS ISSUED PURSUANT TO THE ENGINEERING SERVICES AGREEMENT DATED 2ND AUGUST 2024 BETWEEN CLIENT AND HATCH ASSOCIATES CONSULTANTS, INC ("HATCH"), UNLESS OTHERWISE AGREED IN WINTON WITH CLIENT OR SPECIFIED ON THIS DRAWING, (I, HATCH DOES NOT ACCEPT AND ISSICIALISMS ANY ADAIL LIABILITY OF RESPONSIBILITY ASSIGNS FORM ANY USE OF OR RELIAND THIS DRAWING SAW ANY THIRD PARTY OR ANY MODIFICATION OR MISUSE OF THIS DRAWING SEY OF LITTLE AND ALL INTELLECTUAL PROPERTY RIGHTS EMBODIED OR REFERENCED IN THIS DRAWING SEY.

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DESIGNED BY DATE PROJECT NUMBER

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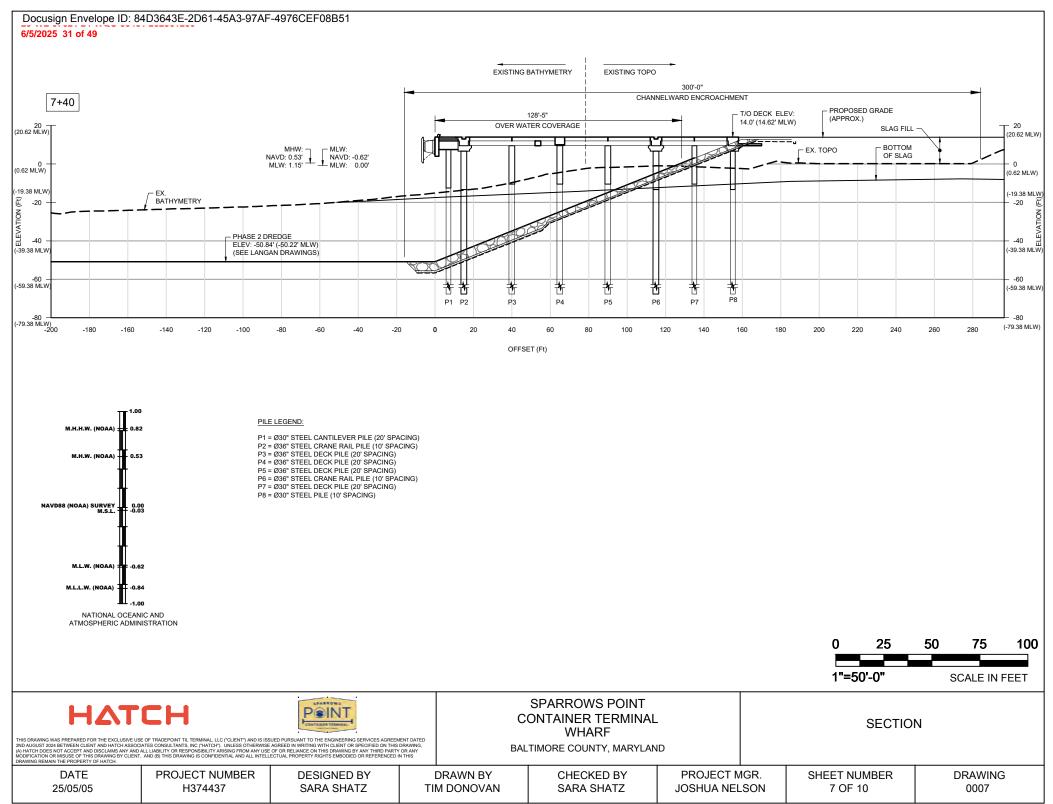
SARA SHATZ


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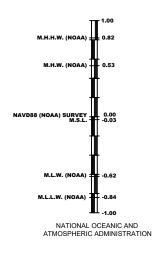
TIM DONOVAN

PROJECT MGR. JOSHUA NELSON

SHEET NUMBER **DRAWING** 6 OF 10 0006





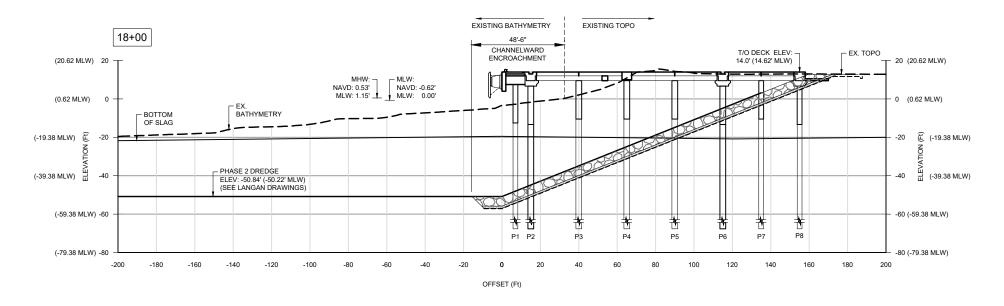

PILE LEGEND:

P1 = 030° STEEL CANTILEVER PILE (20' SPACING)
P2 = 030° STEEL CRANE RAIL PILE (10' SPACING)
P3 = 030° STEEL DECK PILE (20' SPACING)
P4 = 030° STEEL DECK PILE (20' SPACING)
P5 = 030° STEEL DECK PILE (20' SPACING)
P6 = 030° STEEL CRANE RAIL PILE (10' SPACING)
P7 = 030° STEEL DECK PILE (20' SPACING)
P8 = 030° STEEL DECK PILE (20' SPACING)

0 25 50 75 100 1"=50'-0" SCALE IN FEET

HATCH





SPARROWS POINT
CONTAINER TERMINAL
WHARF
ITHIS DRAING,
BALTIMORE COUNTY, MARYLAND

SECTION

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DESIGNED BY DATE PROJECT NUMBER **DRAWN BY CHECKED BY** PROJECT MGR. SHEET NUMBER **DRAWING** 25/05/05 H374437 SARA SHATZ **TIM DONOVAN** SARA SHATZ JOSHUA NELSON 8 OF 10 0008



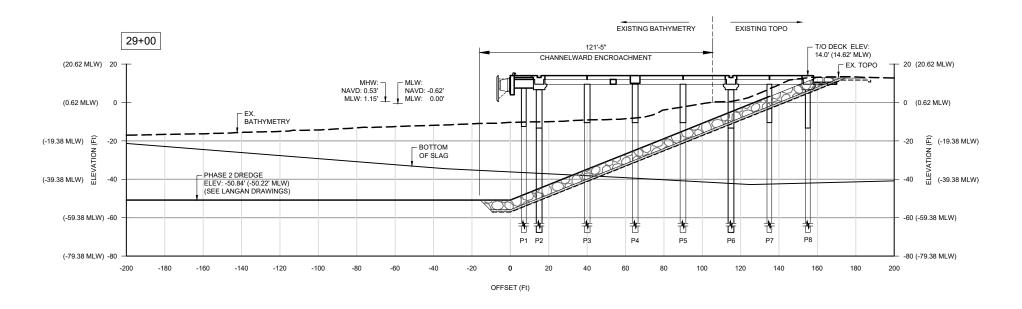

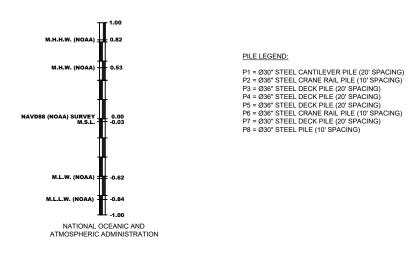

HATCH

DATE

25/05/05



SPARROWS POINT CONTAINER TERMINAL WHARF

BALTIMORE COUNTY, MARYLAND

SECTION

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H374437 SARA SHATZ TIM DONOVAN SARA SHATZ JOSHUA NELSON 9 OF 10 0009

PILES WITHIN CURRENT STATE TIDAL WETLANDS			
DIAMETER	QUANTITY	AREA (FT²)	
30"	139	682.5	
36"	415	2933.5	
	554	3616.0	
		0.08	ACRE

REVETMENT WITHIN CURRENT STATE TIDAL WETLANDS			
AREA (FT²)			
BENEATH AND IN FRONT OF WHARF	203,439		
OUTSIDE OF WHARF ON BOTH ENDS	48,628		
	252,067		
	5.79	ACRE	

PILES WITHIN PROPOSED TIDAL WETLANDS*			
DIAMETER	QUANTITY	AREA (FT²)	
30"	153	751.2	
36"	1061	7501.3	
	1214	8,252.5	
		0.19	ACRE

REVETMENT WITHIN PROPOSED TIDAL WETLANDS*			
AREA	AREA (FT²)		
BENEATH AND IN FRONT OF WHARF	433,734		
OUTSIDE OF WHARF ON BOTH ENDS	89,523		
	523,257		
	12.01	ACRE	

QUANTITIES SHOWN ARE WITHIN ALL PROPOSED TIDAL WETLANDS, INCLUDING CURRENT STATE TIDAL WETLANDS

NINE SHIIP-TO-SHORE (STS) CRANES ACTIVE CRANES: MAX HEIGHT OF 330' ABOVE WHARF DECK STORED CRANES: MAX HEIGHT OF 484' ABOVE WHARF DECK



SLAG FILL AREA = 12,468FT² (0.3 ACRES)



25/05/23



SPARROWS POINT CONTAINER TERMINAL WHARF BALTIMORE COUNTY, MARYLAND

IMPACT

THIS DRAWING WAS PREPARED FOR THE EXCLUSIVE USE OF TRADEPOINT TIL TERMINAL, LLC ("CLIENT") AND IS ISSUED PURSUANT TO THE ENGINEERING SERVICES AGREEMENT DATED 2ND AUGUST 2024 BETWEEN CLIENT AND HATCH ASSOCIATES CONSULTANTS, INC ("HATCH"). UNLESS OTHERWISE AGREED IN WRITING WITH CLIENT OR SPECIFIED ON THIS DRAWING (A) HATCH DOES NOT ACCEPT AND BISCLAMS ANY AND ALL LIABILITY OR RESPONSIBILITY ASSIGNED FROM ANY USE OF OR RELIANCE ON THIS DRAWING YAN YHITHED ARRY OR ANY MODIFICATION OR MISUSE OF THIS DRAWING BY CLIENT, AND (B) THIS DRAWING SIC CONFIDENTIAL AND ALL INTELLECTUAL PROPERTY RIGHTS EMBODIED OR REFERENCED IN THIS DRAWING BY ANY THIRD PARTY OR ANY MODIFICATION OF MISUSE OF THIS DRAWING SIC CONFIDENTIAL AND ALL INTELLECTUAL PROPERTY RIGHTS EMBODIED OR REFERENCED IN THIS DRAWING SIC CONFIDENTIAL AND ALL INTELLECTUAL PROPERTY RIGHTS EMBODIED OR REFERENCED IN THIS DRAWING SIC CONFIDENTIAL AND ALL INTELLECTUAL PROPERTY RIGHTS EMBODIED OR REFERENCED IN THIS DRAWING SIC CONFIDENTIAL AND ALL INTELLECTUAL PROPERTY RIGHTS EMBODIED OR REFERENCED IN THIS DRAWING SIC CONFIDENTIAL AND ALL INTELLECTUAL PROPERTY RIGHTS EMBODIED OR REFERENCED IN THIS DRAWING SIC CONFIDENTIAL AND ALL INTELLECTUAL PROPERTY RIGHTS EMBODIED OR REFERENCED IN THIS DRAWING SIC CONFIDENTIAL AND ALL INTELLECTUAL PROPERTY RIGHTS EMBODIED OR REFERENCED IN THIS DRAWING SIC CONFIDENTIAL AND ALL INTELLECTUAL PROPERTY RIGHTS EMBODIED OR REFERENCED IN THIS DRAWING SIC CONFIDENTIAL AND ALL INTELLECTUAL PROPERTY RIGHTS EMBODIED OR REFERENCED IN THIS DRAWING SIC CONFIDENTIAL AND ALL INTELLECTUAL PROPERTY RIGHTS EMBODIED OR REFERENCED IN THIS DRAWING SIC CONFIDENTIAL AND ALL INTELLECTUAL PROPERTY RIGHTS EMBODIED OR REFERENCED IN THIS DRAWING SIC CONFIDENTIAL AND ALL INTELLECTUAL PROPERTY RIGHTS EMBODIED OR REFERENCED IN THIS DRAWING SIC CONFIDENTIAL AND ALL INTELLECTUAL PROPERTY RIGHTS EMBODIED OR REFERENCED IN THIS DRAWING SIC CONFIDENTIAL AND ALL INTELLECTUAL SIC CONFIDENTIAL SIC CONFIDENTIAL SIC CONFIDENTIAL SIC CONFIDENTIAL SIC CONFIDENTIAL SIC CONFIDENTIA

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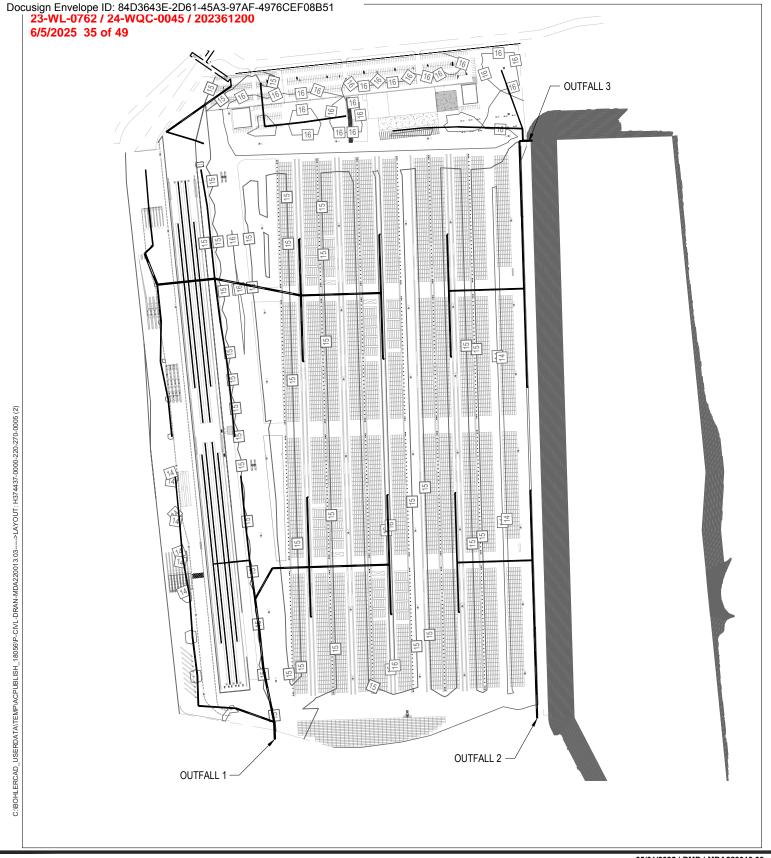
DATE PROJECT NUMBER

DESIGNED BY SARA SHATZ

DRAWN BY TIM DONOVAN **CHECKED BY** SARA SHATZ

PROJECT MGR. JOSHUA NELSON SHEET NUMBER 10 OF 10

DRAWING 0010





901 DULANEY VALLEY ROAD, SUITE 801 TOWSON, MARYLAND 21204


Phone: (410) 821-7900 Fax: (410) 821-7987 **MD@BohlerEng.com**


SPARROWS POINT CONTAINER TERMINAL



05/01/2025 | DMD | MDA220013.03



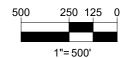

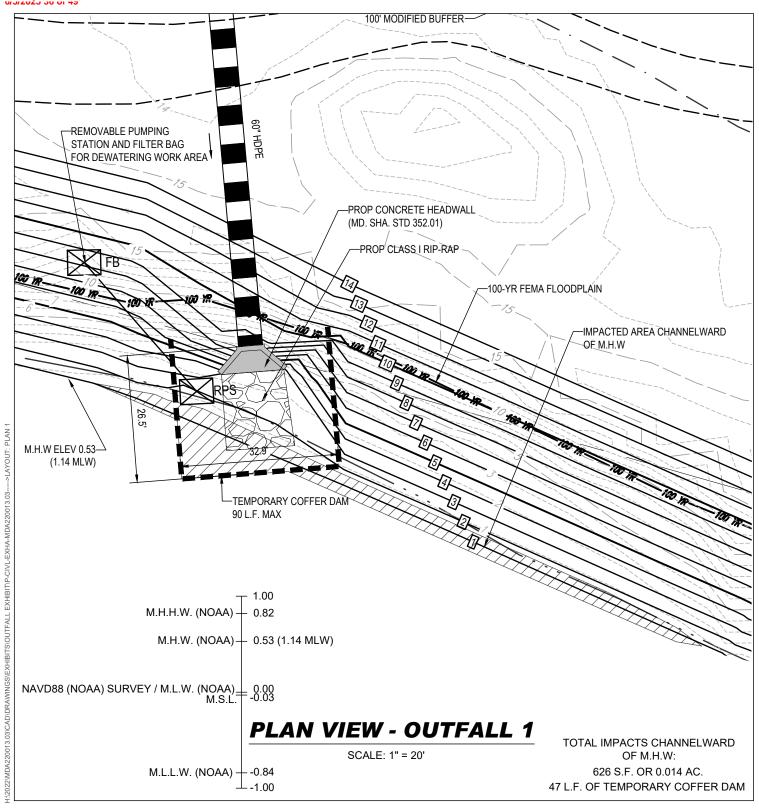



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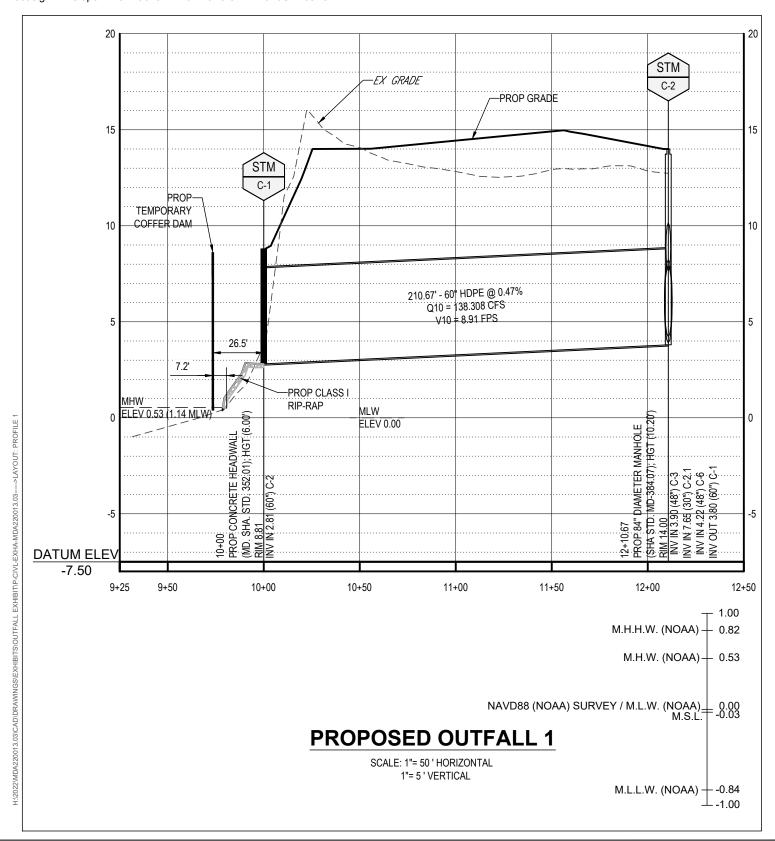
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SPARROWS POINT CONTAINER TERMINAL

TRADEPOINT ATLANTIC BALTIMORE, MD 21219 1/7/25 | DMD | MDA220013.03










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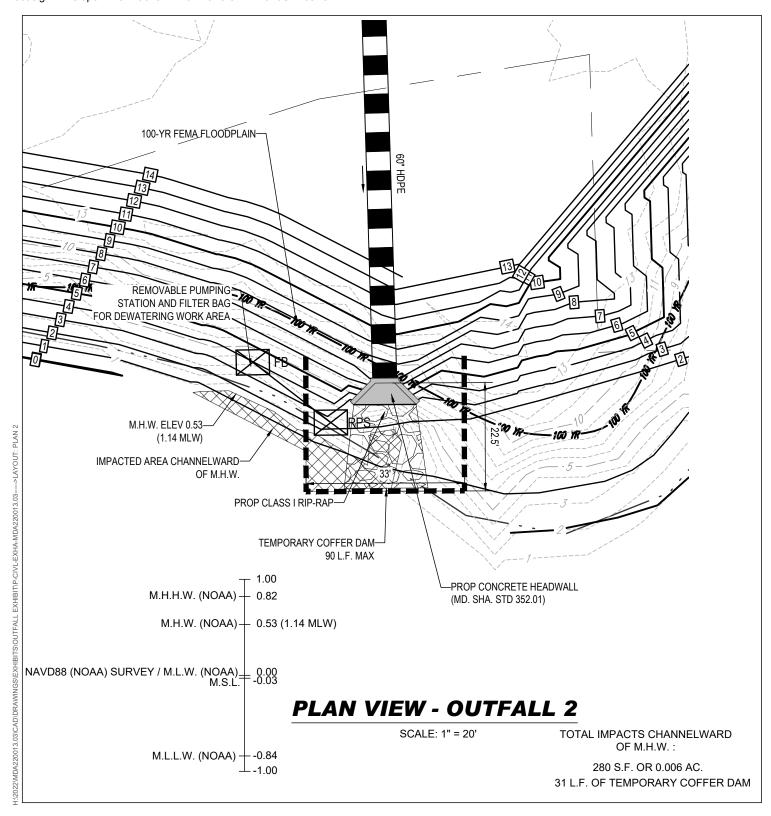
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SPARROWS POINT CONTAINER TERMINAL



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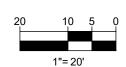




SPARROWS POINT CONTAINER TERMINAL

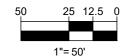ATLANTIC BALTIMORE, MD 21219






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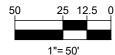
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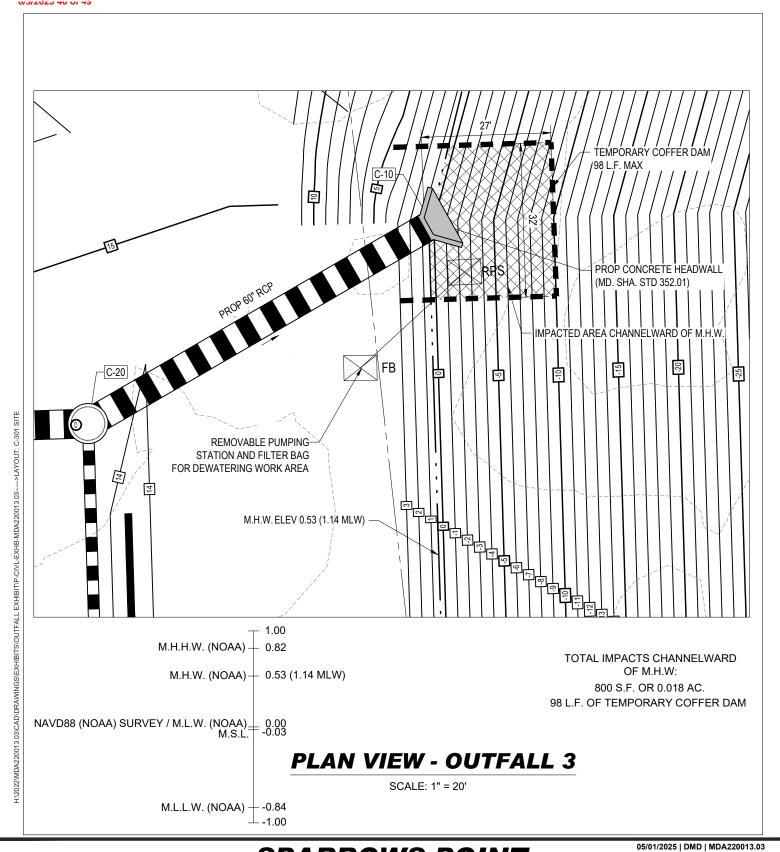
TRADEPOINT ATLANTIC BALTIMORE, MD 21219






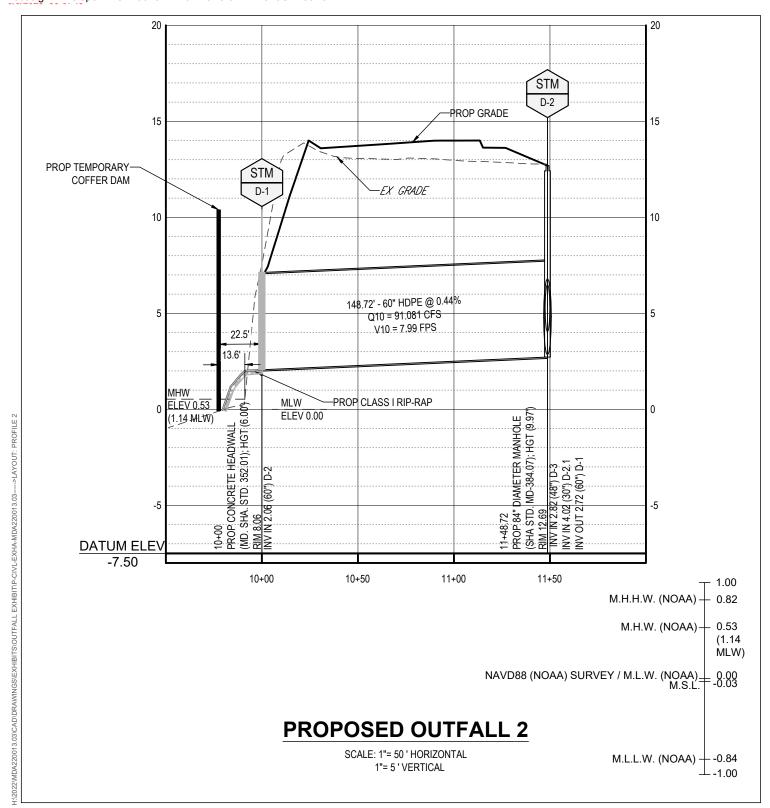

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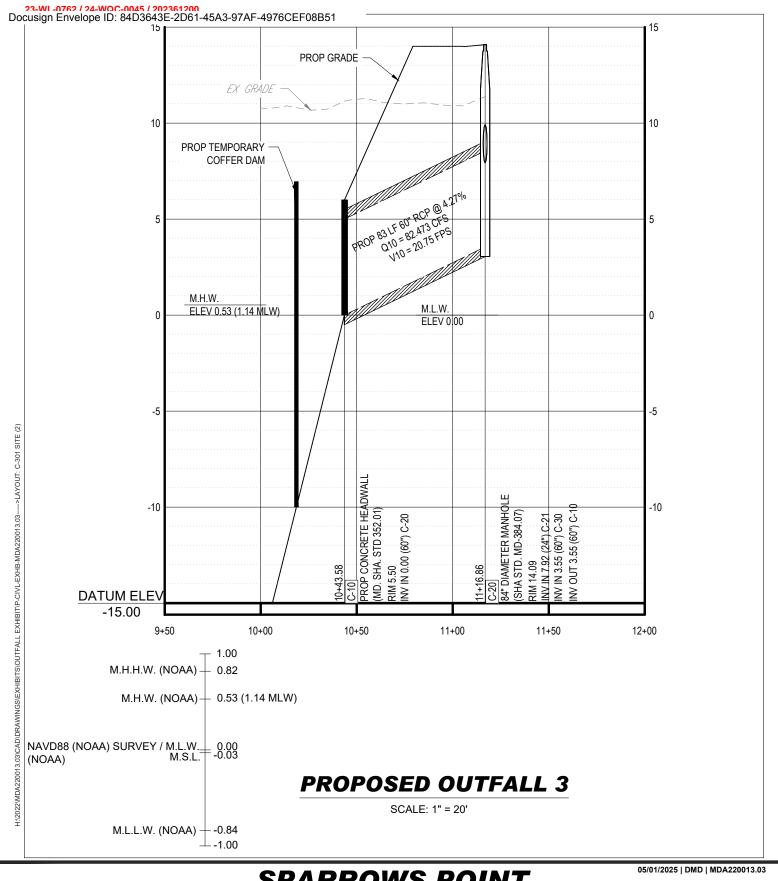


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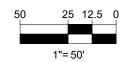
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SPARROWS POINT CONTAINER TERMINAL



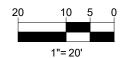



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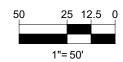
SWM OUTFALLS IMPACT SUMMARY TABLE		
QUANTITY OF TEMPORARY OUTFALLS (EA)	0	
QUANTITY OF PERMANENT OUTFALLS (EA)	3	
EXTENT OF OUTFALLS CHANNELWARD OF MHWL (SF)	65 L.F.	
	OUTFALL #1: 60" DIAMETER OUTFALL, WITH 15'X20' STONE, 20' CHANNELWARD OF MHWL.	
LENGTH X WIDTH OF PIPE AND/OR ASSOCIATED STONE STRUCTURE X # OF OUTFALLS (SF)	OUTFALL #2: 60" DIAMETER OUTFALL, WITH 15'X20' STONE, 15' CHANNELWARD OF MHWL.	
	OUTFALL #3: 60" DIAMETER OUTFALL, 30' CHANNELWARD OF MHWL.	

			,
Outfall 1			
Max Length	28.5	LF	
Max Width	32.9	LF	
Total Area Channelward of MHWL	626	SF	
Max. Channel ward Encroachment =	20	LF	
Max. Temporary Impact (Including within the Cofferdam) =	872	SF	
Outfall 2			
Max Length	22.5	LF	
Max Width	33	LF	
Total Area	280	SF	
Max. Channel ward Encroachment =	23	LF	
Max. Temporary Impact (Including within the Cofferdam) =	743	SF	
Outfall 3			
Max Length	27	LF	
Max Width	32	LF	
Total Area	800	SF	
Max. Channel ward Encroachment =	98	LF	
			NOTE Impact is within the impact area already accounted
Max. Temporary Impact (Including within the Cofferdam) =	864	SF	for for the revetment

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H32022/MDA220013.03/CAD1DRAWINGS\EXHIBITS\OUTFALL EXHIBITP-CIVL-EXHB-MDA220013.03---->LAYOUT: IMPACT SUMMARY

SPARROWS POINT CONTAINER TERMINAL





05/01/2025 | DMD | MDA220013.03

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ATLANTIC
BALTIMORE, MD 21219





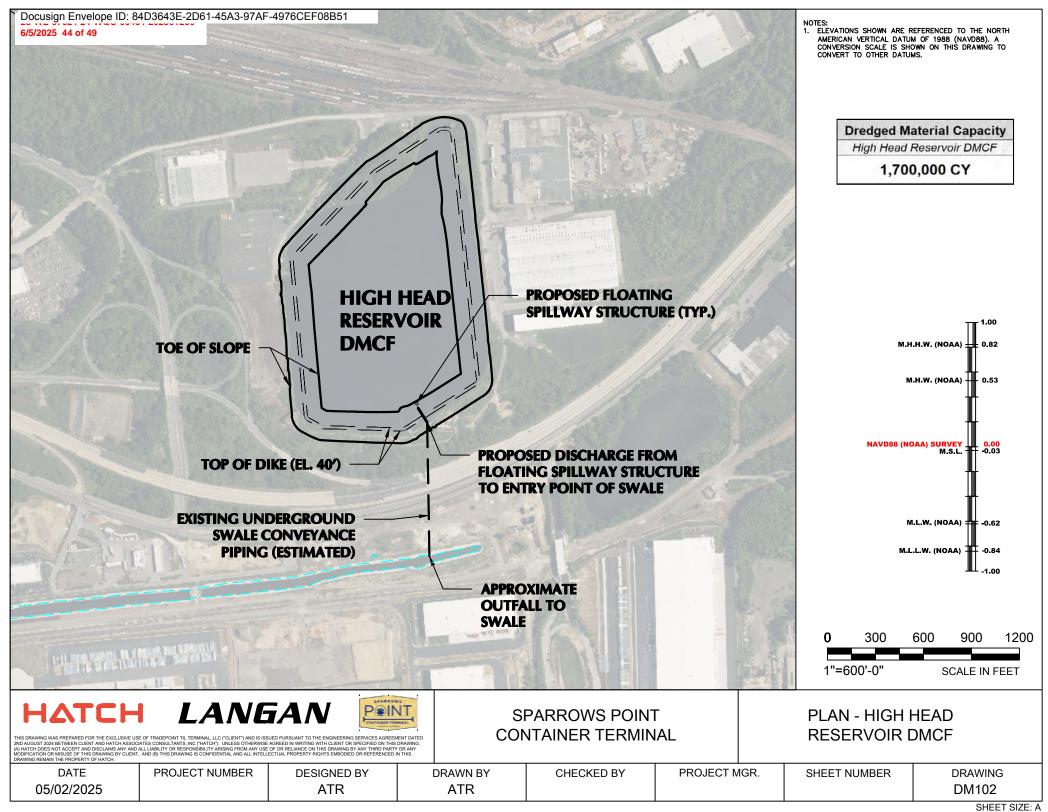
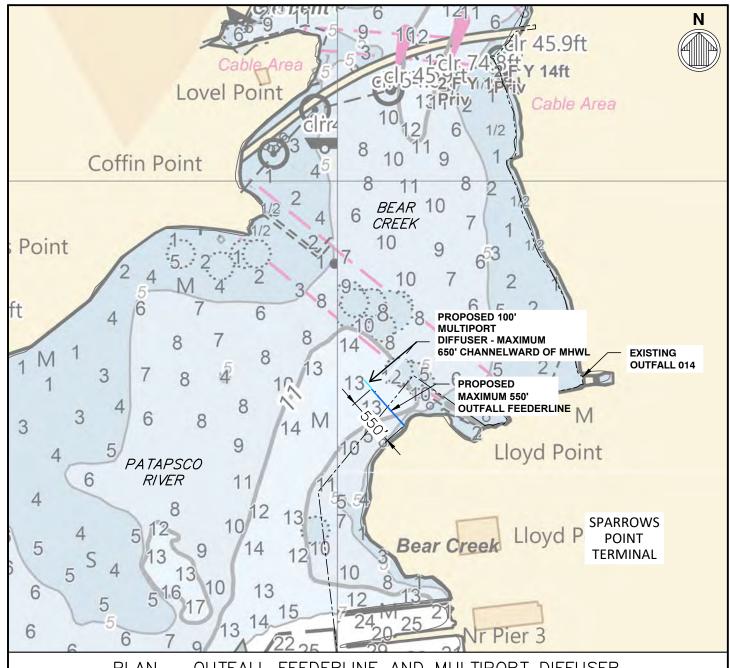
<u>PLAN - OUTFALL FEEDERLINE AND MULTIPORT DIFFUSER</u>


NOTES


- TEMPORARY OUTFALL WITH DIFFUSER INSTALLED DURING DREDGED MATERIAL PLACEMENT AND DEWATERING.
- 2. EXISTING DEPTHS SHOWN IN FEET BASED ON CUSTOM CHART RENDERED FROM NOAA ELECTRONIC NAVIGATIONAL CHART DATA.
- 3. SEE NEXT SHEET FOR SECTION VIEW.

APPLICATION BY:
TRADEPOINT ATLANTIC
6995 BETHLEHEM BLVD.
BALTIMORE, MARYLAND 21219

HIGH HEAD INDUSTRIAL BASIN DMCF OUTFALL AND DIFFUSER

PROJECT LOCATION:
PATAPSCO RIVER / BEAR CREEK
BALTIMORE COUNTY, MARYLAND

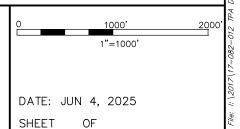

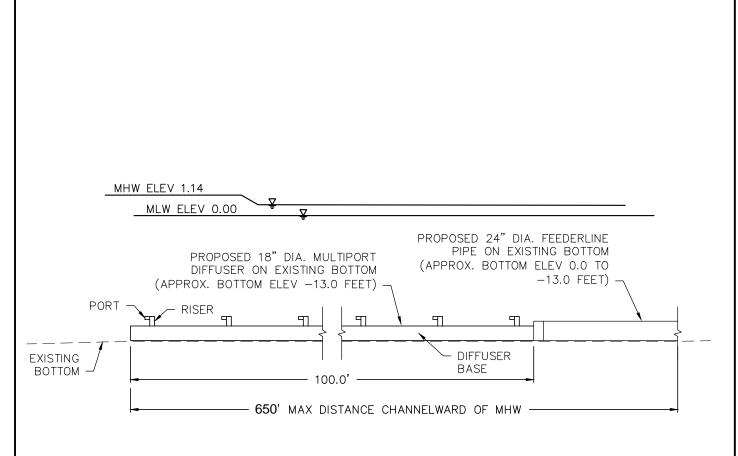

SECTION - OUTFALL FEEDERLINE AND MULTIPORT DIFFUSER


NOTES

1. FEEDERLINE AND DIFFUSER TO BE SECURED TO BOTTOM USING STRAPS/CLAMPS AND ANCHORS.


APPLICATION BY: TRADEPOINT ATLANTIC 6995 BETHLEHEM BLVD. BALTIMORE, MARYLAND 21219

HIGH HEAD INDUSTRIAL BASIN DMCF OUTFALL AND DIFFUSER

PROJECT LOCATION:
PATAPSCO RIVER / BEAR CREEK
BALTIMORE COUNTY, MARYLAND

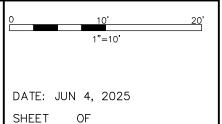

 $i: \langle 2017 \rangle 17-082-012$ TPA Dredge Permitting Support PO 3834 $\langle 003 \rangle H$ DMCF Diffuser JPA $\langle 240 \rangle H$ Diffuser -P002-8; Plotted: 6/5/2025 6:49 PM by PAUL NEVENGLOSKY; Soved: 6/5/2025 6:49 PM by PNEVENGLOSK

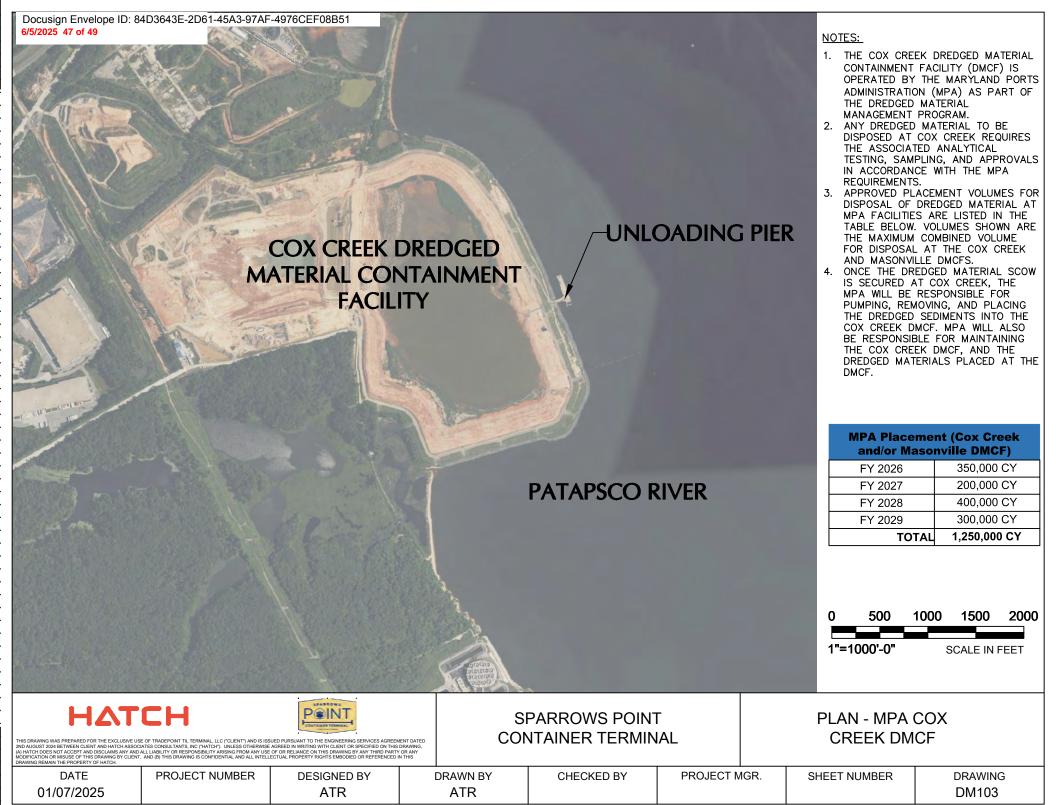



NOTES:

- 1. THE MASONVILLE DREDGED MATERIAL CONTAINMENT FACILITY (DMCF) IS OPERATED BY THE MARYLAND PORTS ADMINISTRATION (MPA) AS PART OF THE DREDGED MATERIÁL MANAGEMENT PROGRAM.
- 2. ANY DREDGED MATERIAL TO BE DISPOSED AT MASONVILLE REQUIRES THE ASSOCIATED ANALYTICAL TESTING, SAMPLING, AND APPROVALS IN ACCORDANCE WITH THE MPA REQUIREMENTS.
- 3. APPROVED PLACEMENT VOLUMES FOR DISPOSAL OF DREDGED MATERIAL AT MPA FACILITIES ARE LISTED IN THE TABLE BELOW. VOLUMES SHOWN ARE THE MAXIMUM COMBINED VOLUME FOR DISPOSAL AT THE COX CREEK AND MASONVILLE DMCFS.
- ONCE THE DREDGED MATERIAL SCOW IS SECURED AT MASONVILLE, THE MPA WILL BE RESPONSIBLE FOR PUMPING, REMOVING, AND PLACING THE DREDGED SEDIMENTS INTO THE COX CREEK DMCF. MPA WILL ALSO BE RESPONSIBLE FOR MAINTAINING THE COX CREEK DMCF, AND THE DREDGED MATERIALS PLACED AT THE DMCF.

MPA Placement (Cox Creek and/or Masonville DMCF)		
FY 2026	350,000 CY	
FY 2027	200,000 CY	
FY 2028	400,000 CY	
FY 2029	300,000 CY	
TOTAL	1,250,000 CY	

400 800 1600 1200 1"=800'-0" SCALE IN FEET




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CONTAINER TERMINAL

PLAN - MPA MASONVILLE DMCF

PROJECT MGR. DATE PROJECT NUMBER **DESIGNED BY DRAWN BY** CHECKED BY SHEET NUMBER **DRAWING** 01/07/2025 **ATR** DM104 ATR

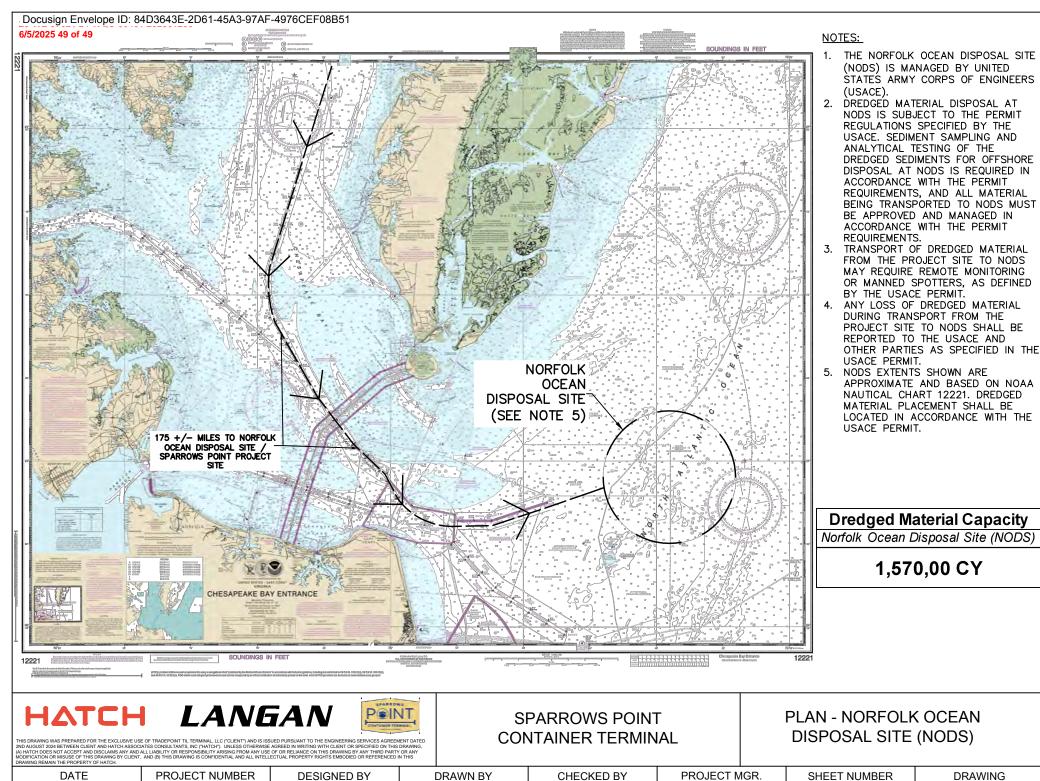

ATR

ATR

05/21/2025

SHEET SIZE: A

DM105